GENERAL CONDITIONS:

- 1. These drawings are the exclusive property of the architect and may only be reproduced with the written permission of the architect.
- 2. The contractor shall be responsible for providing all work and materials in accordance with the International Residential Code (IRC) as well as all applicable national, state, county and city codes (building, fire, health, energy, ventilation, plumbing, mechanical, electrical, etc.)
- 3. The contractor shall be governed by all conditions as indicated in the construction documents and specifications.
- **4.** If the contractor is aware of any discrepancy between the work as shown and requirements of codes and governing agencies, they shall notify the architect and await further instruction. **5.** The contractor shall verify all dimensions. datum, levels, and the site conditions prior to commencing the work. The contractor shall report any discrepancies and/or omissions to the architect prior to commencing the work.
- **6.** All work shall be accomplished by qualified trade people in the specific field with required certification where applicable.
- 7. All work shall be performed to the established trade standards using the most suitable construction methods in such trade. Aforementioned construction to include the use of applicable standard components, connectors, supports, trim, backing, blocking and/or other appurtenances.
- 8. Set work to required levels and lines, with members plumb, true to line, cut, and fitted. Fit work to other construction; scribe and cope as needed for accurate fit. Locate furring, nailers, blocking, grounds, and similar supports to comply with requirements for attaching other construction.
- **9.** These drawings indicate general and typical details of construction. Where conditions are not specifically indicated but are of a similar character to the details shown, similar details of construction shall be used. Repetitive features not noted on the drawings shall be completely provided as if drawn in full.
- **10.** Do not scale drawings. All dimensions are from face of rough framing or face of concrete unless noted otherwise. Check details for location of items not dimensioned on the plans.
- **11.** All rough opening measurements shall be verified by the contractor.
- **12.** The contractor shall coordinate the securing of required permits and approvals with the owner.

NORTH ARROW

PROJECT NORTH

6 ROOF SLOPE (RISE, RUN)

ELEVATION TAG

S.D. DETECTOR/ALARM

(REFER TO SCHEDULE) \longrightarrow SLIDING DOOR/ WINDOW

SYMBOLS:

FAN TYPE (REFER

1) **L**DOOR NUMBER

TO SCHEDULE)

₩WINDOW LETTER

RISE:RUN

LEGEND:

DOOR TAG

WINDOW TAG

EXHAUST FAN

- **13.** The contractor shall schedule on-site inspections per the building official.
- **14.** Electrical, plumbing and mechanical systems are to be bidder designed. The contractor will be responsible to produce drawings for the architect and owner to review and approve, prior to the start of installation, and to obtain all necessary permits in connection with the work.
- **15.** No deviations from or changes to the structural system shall be made without approval from the architect and engineer.
- **16.** All changes in plans and field modifications shall be approved by the building official
- 17. Shop drawings are required for, but not limited to, trusses, structural steel connections and fabrications. The contractor shall prepare and submit shop drawings to the architect for review and approval, and then submit to the building official. All shop drawing dimensions shall be checked and verified in the field by the contractor.
- **18.** It shall be the responsibility of the contractor to locate all existing utilities whether shown herein or not and to protect them from damage. The contractor shall bear all expense of repairs or replacement of utilities or other property damaged by operations in conjunction with the execution of the work.
- **19.** The contractor shall provide temporary facilities as required by code.
- **20.** The contractor shall provide all shoring, barricading and bracing necessary to ensure the structural stability of the project, and the health and safety of the public and all who enter the property during construction.
- 21. The contractor shall keep areas under construction secure and clear of dirt and
- 22. The contractor shall schedule work, as much as possible, to avoid inconveniences of existing neighborhood property owners.
- **23.** The contractor shall provide all accessories required for a completely watertight installation including but not necessarily limited to: flashing, counter flashing, sealant, and caulking at all roof and floor penetrations, interlocking weather stripping at all doors and windows, water stops and other concrete inserts at below grade cold joints.
- **24.**See construction notes & details for additional concrete, steel, & rough carpentry requirements.

ELEVATION NUMBER

1 SECTION NUMBER

★SECTION NUMBER

SECTION NUMBER

A3 ← SHEET NUMBER

A3 ← SHEET NUMBER

& DIRECTION

6 CSHEET NUMBER

INTERIOR ELEVATION

DETAIL CUT TAG

WALL SECTION CUT TAG

BUILDING SECTION CUT TAG

ABBREVIATIONS:

ABE	5	REVIATIONS:			PROPERI
A.B.	_	Anchor bolt	I.C.F.	= Insulated concrete form	PROPERTY OWNER:
A.B. A.F.F.		Above finish floor	JST	= Joist	PROPERTY ADDRESS:
ABV		Above	K.D.	= Kiln Dried	
ADD		Addition	L	= Length	PARCEL NUMBER:
ALT.		Alternating	L.D.	= Linear feet	QUARTER - SECTION-
AWN		Awning	LAV	= Lavatory	TOWNSHIP - RANGE: LEGAL DESCRIPTION:
B.F.	=	Bi-fold Bi-fold	LOC	= Location	LEGAL DESCRIPTION.
B.P.	=	Bi-pass	M.O.	= Masonry opening	
B/I		Built-in	MATL	= Material	
B/U		Built-up	MAX	= Maximum	
BLDG		Building	MECH	= Mechanical	
BLKG		Blocking	MFR	= Manufacturer	
BLW		Below	MIN	= Minimum	
BM		Beam	MTL (NI)	= Metal = New	
BRD BRG		Board Bearing	(N) N.A.	= Not applicable	
BSBL		Building Setback Line	N.I.C.	= Not in contract	GROSS SITE AREA:
C.F.		Cubic feet	N.T.S.	= Not to scale	BASE SITE AREA:
C.J.		Control joint	0/	= Over	DEVELOPABLE SITE:
C.L., L		Center line	O.C.	= On center	WATER:
CALC		Calculation	O.D.	= Outside diameter	SEWER:
CANT	=	Cantilever	O.H.	= Over hang	FIRE FLOW:
CAS	=	Casement	O.H.D.	= Overhead door	= . =
CLG	=	Ceiling	ODWH	= On Demand Water Heater	
CLR	=	Clear	OPP	= Opposite	ERU:
COL		Column	OPTL	= Optional	POWER:
CONC		Concrete	PLAM	= Parallam	
CONST		Construction	P.T.	= Pressure Treated	CODE INFO
CONT		Continuous	PD	= Plumbing Drop	CODE IIII
		Coordinate	PERP	= Perpendicular	
CSMT		Casement	PKT	= Pocket	JURIDICTION:
D		Depth Double hung	PL, P L	= Plate	ZONING:
D.H. DBL		Double hung Double	PLMG	= Plumbing	NEIGHBORHOOD:
DEMO		Demolish	PLYWD	= Plywood	DESIGN STANDARDS:
DIA,Ø		Diameter	PSF	= Per Square Foot	
DIM		Dimension	R R.O.	= Riser	SETBACKS:
DN		Down	R.S.	= Rough Opening= Rough Sawn	
DR		Door		= Rough Sawn == Thermal Resistance	FENCES:
DS	=	Down Spout	REF	= Refrigerator	BASE BLDG. HEIGHT:
DTL	=	Detail	REQD	= Required	2, 102 222 01112101111
DWG	=	Drawing	REV	= Revision	MAX. BLDG. HEIGHT:
E.J.	=	Expansion joint	RFTR	= Rafter	IMPERVIOUS (ZONING)
E.W.	=	Each way	S	= Sink	PERVIOUS (ZONING):
EA		Each	S&P	= Shelf & pole	IMPERVIOUS
EL		Elevation	S.C.	= Solid core wood	(ENGINEERING):
E.P.D.M.	=	Ethylene Propylene	S.D.	= Smoke detector	FLOOR AREA RATIO:
EO	_	Diene Monomer	S.F.	= Square feet	OCCUBANCY:
EQUID		Equal	S.G.	= Safety glass	OCCUPANCY:
EQUIP ESMT		Equipment Easement	S.H.	= Single hung	DAYCARE TYPE:
EXG		Existing	S.O.G. S.W.	= Slab on grade= Shear wall	CONSTRUCTION TYPE
EXP		Exposure	SHT	= Sheet	TYPE OF CONSTR.:
EXT		Exterior	SHTG	= Sheeting	GROSS FLOOR AREA:
F		Fixed	SIM	= Similar	
F.D.	=	Floor Drain	SLDR	= Slider	LANDSCAPE RQMTS:
F.F.	=	Finish Floor	SPEC	= Specifications	
F.P.	=	Fire Place	STD	= Standard	
F.V.		Field verify	STL	= Steel	DADIZINO DOMTO
FDN		Foundation		= Structural	PARKING RQMTS:
FIN		Finish	T	= Tread	MAX. OCCUPANTS: STALLS PER OCCUP:
FL		Flush	T&G	= Tongue and groove	COMPACT STALLS:
FLR FRDR		Floor Franch Door	T.O.B.	= Top of beam	EVSE STALLS:
FRMG		French Door Framing	T.O.S.	= Top of slab	EV-READY STALLS:
FTG		Footing	T.O.W.	= Top of wall	TOTAL STALLS:
F.S.C.		Forest Stewardship Council	TEMP THK	= Temporary = Thick	STALL TYPES:
G.F.I.		Ground fault interrupt	TYP	= Trick = Typical	BICYCLE:
G.F.I. G.W.B.		Gypsum wall board	U.N.O.	= Unless noted otherwise	
GA GA		Gauge	UNHTD	= Un-heated space	BUILDING CODE:
GALV		Galvanized	V.B.	= Vapor barrier	
GL		Glass, glazing	V.T.O.	= Vent to outside	
GLB		Gluelam beam	V.I.F.	= Verify in field	
H, HT	=	Height	VERT	= Vertical	
H.B.		Hose bibb	W	= Width	
нС	=	Hollow core wood	\///	= With	

= With

= Without

= Wood

= Window

= Waterproof

W/O

WD

WIN

= Washer/Dryer

= Water Closet

= Walk in Closet

= Hollow core wood

= Header

= Horizontal

= Hot Water Tank

= Inside Diameter

HDWD = Hardwood

INSUL = Insulation

= Interior

PROJECT SUMMARY:

THE PROJECT IS TO BUILD A NEW DAYCARE CENTER AT 355 E. SUNSET WAY. THE DAYCARE IS PLANNED TO ACCOMMODATE 59 CHILDREN AND 8 TEACHERS. THE DAYCARE BUILDING IS PROPOSED TO BE A 2 STORY STRUCTURE OF ABOUT 3.540 SF TO OUTSIDE OF EXT. WALL. THERE WILL BE AN OUTDOOR PLAY AREA AND 15 PARKING STALLS ACCESSED FROM THE ALLEY. ALL EXISTING IMPROVEMENTS WILL BE REMOVED.

PROPERTY INFO:

ROPERTY OWNER: THARAKA & DEEPTHI DEVADITHYA ROPERTY ADDRESS: 355 EAST SUNSET WAY ISSAQUAH, WA 99029 342406-9096 ARCEL NUMBER: QUARTER - SECTION- NW - 34 - 24 - 6 TOWNSHIP - RANGE LEGAL DESCRIPTION: THAT PORTION OF THE NORTHWEST QUARTER OF THE NORTHEAST

QUARTER OF THE NORTHWEST QUARTER OF SECTION 34, TOWNSHIP 24 NORTH, RANGE 6, W.M. IN KING COUNTY, WASHINGTON, DESCRIBED AS TRAFFIC ENGINEER: FOLLOWS: BEGINNING AT A POINT ON THE SOUTH LINE OF MILL STREET, WHICH IS 30 FEET SOUTH AND EAST OF THE NORTHWEST CORNER OF SAID SUBDIVISION; THENCE EAST ALONG SAID SOUTH LINE 110 FEET; THENCE SOUTH 120 FEET; THENCE WEST 110 FEET; THENCE NORTH 120 FEET TO BEGINNING. SITUATE IN THE CITY OF ISSAQUAH, COUNTY OF KING, STATE OF WASHINGTON.

13.200 SF (0.30 ACRES) ROSS SITE AREA: BASE SITE AREA: 13,200 SF (0.30 ACRES EVELOPABLE SITE: 13,200 SF (0.30 ACRES

VATER: CITY OF ISSAQUAH EWER: CITY OF ISSAQUAH **IRE FLOW:** STATIC PRESSURE - 73 PSI AVAILABLE FLOW - 2,292 GPM

AVAILABLE FLOW PRESSURE - 66 PSI RU: 1 ERU = 2,000 SF IMPERV; 3.3 ERU's OWER: **EXISTING FROM ALLEY**

CODE INFORMATION:

URIDICTION: CITY OF ISSAQUAH ONING: **EIGHBORHOOD:** OLDE TOWN

ESIGN STANDARDS: OLDE TOWN DESIGN STANDARDS

SETBACKS: FRONT - 10 FT SIDE - 5 FT REAR - 20 FT ENCES:

6 FT HIGH SOLID FENCE AROUND PLAY AREAS 40 FT - FROM LOWEST OF AVE. FINISH OR EXST. GRADE TO BASE BLDG. HEIGHT:

MID-POINT OF HIGHEST GABLE MAX. BLDG. HEIGHT: SAME AS BASE BLDG. HEIGHT MPERVIOUS (ZONING): 50% MAX. (SEE SHEET A0.1 FOR CALCULATIONS) 50% MIN. (SEE SHEET A0.1 FOR CALCULATIONS) /IPERVIOUS ENGINEERING): SEE CIVIL DRAWINGS

3,376 SF / 13,200 SF = 0.26

E - EDUCATIONAL (ALL CHILDREN 2 1/2 YRS. OR LESS TO BE CCUPANCY: LOCATED ON MAIN FLOOR W/ DIRECT ACCESS TO OUTSIDE)

AYCARE TYPE: DAY CARE CENTER CONSTRUCTION TYPE: TYPE V-B YPE OF CONSTR.: WOOD ROSS FLOOR AREA: 3,376 SF

FRONT YARD: TYPE 3 - SEE LANDSCAPE DRWGS. ANDSCAPE RQMTS: SIDE YARDS: TYPE 3 - SEE LANDSCAPE DRWGS. REAR YARD: TYPE 2 - SEE LANDSCAPE DRWGS.

PARKING RQMTS: 1AX. OCCUPANTS: 59 CHILDREN, 8 TEACHERS STALLS PER OCCUP: 1 STALL PER 6 CHILDREN + 1 STALL PER TEACHER COMPACT STALLS: 60% MAX. VSE STALLS: 5% REQ'D. 1 PROVIDED V-READY STALLS: 10% REQ'D. 2 PROVIDED OTAL STALLS: 18 STALLS

STALL TYPES: 6 STANDARD / 11 COMPACT / 1 BARRIER FREE VAN SICYCLE: 2 BICYCLE STALLS

> 2018 INTERNATIONAL BUILDING CODE (CH 51-50 WAC) 2018 INTERNATIONAL MECHANICAL CODE (CH 51-51 WAC) 2018 NATIONAL FUEL GAS CODE (CH 51-52 WAC) 2018 INTERNATIONAL FUEL GAS CODE (CH 51-52 WAC) 2018 UNIFORM PLUMBING CODE (CH 51-56 WAC) 2018 INTERNATIONAL FIRE CODE (CH 51-54 WAC) - FIRE SPRINKLERS INSTALLED PER NFPA 13 STANDARDS

- FIRE ALARM INSTALLED PER NFPA 72 STANDARDS

2018 WSEC (CH 51-11C WAC) **ENERGY CODE:**

DESIGN CRITERIA: SNOW LOAD: WIND LOAD: 98 MPH (CLASS II STRUCTURE) SEISMIC CATEGORY: FROST DEPTH:

REQUIRED PERMITS: ISSAQUAH:

CHILDREN, YOUTH &

FAMILIES:

ADMINISTRATIVE SITE DEVELOPMENT PERMIT **BUILDING PERMIT**

WA DEPT OF

PLAN REVIEW - APPROVAL ON MAY 5, 2021

PROJECT TEAM

THARAKA & DEEPTHI DEVADITHYA 355 EAST SUNSET WAY ISSAQUAH, WA 98027 **CONTACT: THARAKA** P: 425-830-5391 E: tharakadev@gmail.com

STRUCTURAL ENGINEER: BUKER ENGINEERING LLC. PO BOX 55124 SEATTLE, WA 98155 **CONTACT: DANIEL BUKER** P: 206-258-6333 E: daniel@bukerengineering.com

TRANSPORTATION ENGINEERS NW 11400 SE 8TH ST. STE. 200 BELLEVUE, WA 98004 **CONTACT: CURTIS CHIN** P: 425-250-5003

CIVIL ENGINEER & SURVEYOR:

E: chin@tenw.com

ENCOMPASS ENGINEERING 165 NE JUNIPER ST, STE 201 ISSAQUAH, WA 98027 **CONTACT: BRIANA BENNINGTON** P: 425-961-2160 E: callen@encompasses.net

ARCHITECT

LIVING SHELTER ARCHITECTS 472 FRONT ST. NORTH ISSAQUAH. WA 98027 PRINCIPAL: TERRY PHELAN CONTACT: TROY HOWE P: 425-427-8643 E: troy.howe@livingshelter.com

LANDSCAPE ARCHITECT: BERGER PARTNERSHIP 1927 POST ALLEY, STE. 2 SEATTLE, WA 98101 **CONTACT: SHANNON LESLIE**

P: 206-618-3380 E: shannonl@bergerpartnership.com

MEP ENGINEER:

RENSCH ENGINEERING 111 AVE. C, STE. 104 SNOHOMISH. WA 98290 **CONTACT: YUMI ROTH** P: 360-863-6677 E: yumi.r@renschengineering.com

DRAWING INDEX

COVER: A0.0 COVER SHEET

SURVEY:

SU1.0 SURVEY ARCHITECTURAL:

A0.1 SITE PLAN SITE PHOTOS A1.1 GROUND FLOOR PLAN UPPER FLOOR PLAN A1.3 ROOF PLAN A2.1 NORTH & WEST ELEVATIONS

A2.2 SOUTH & EAST ELEVATIONS A2.3 COLOR PERSPECTIVES

CIVIL:

C1.0 CIVIL COVER SHEET TESC PLAN

TESC DETAILS C3.0 GRADING & DRAINAGE PLAN

C4.0 UTILITY PLAN C5.0 CONSTRUCTION DETAILS C5.1 CONSTRUCTION DETAILS

C5.2 CONSTRUCTION DETAILS

LANDSCAPE:

L1.1 LANDSCAPE CONCEPT PLAN


ELECTRICAL:

E1.1 ELECTRICAL SITE PHOTOMETRIC PLAN E1.2 ELECTRICAL SITE PHOTOMETRIC PLAN & **CUT SHEETS**




VICINITY MAP & PROJECT ADDRESS:

355 SUNSET WAY ISSAQUAH, WA 98027

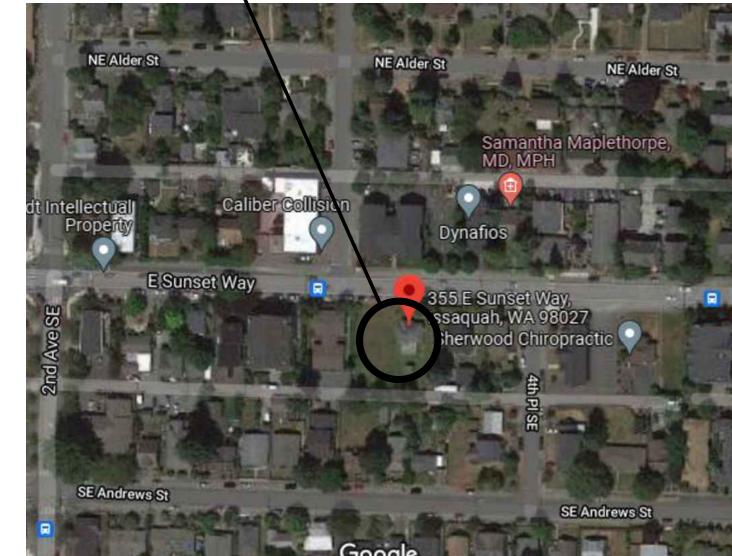

LIVING SHELTER ARCHITECTS PLLC 115 15TH AVE. E. SUITE 100 SEATTLE, WA 98112

(206) 707-8895

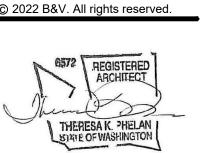

file: **2019262.00** project name: **BRIGHT STARS FAMILY** DAYCARE

THARAKA & DEEPTHI DEVADITHYA project address: 355 EAST SUNSET WAY

ISSAQUAH. WA 98027

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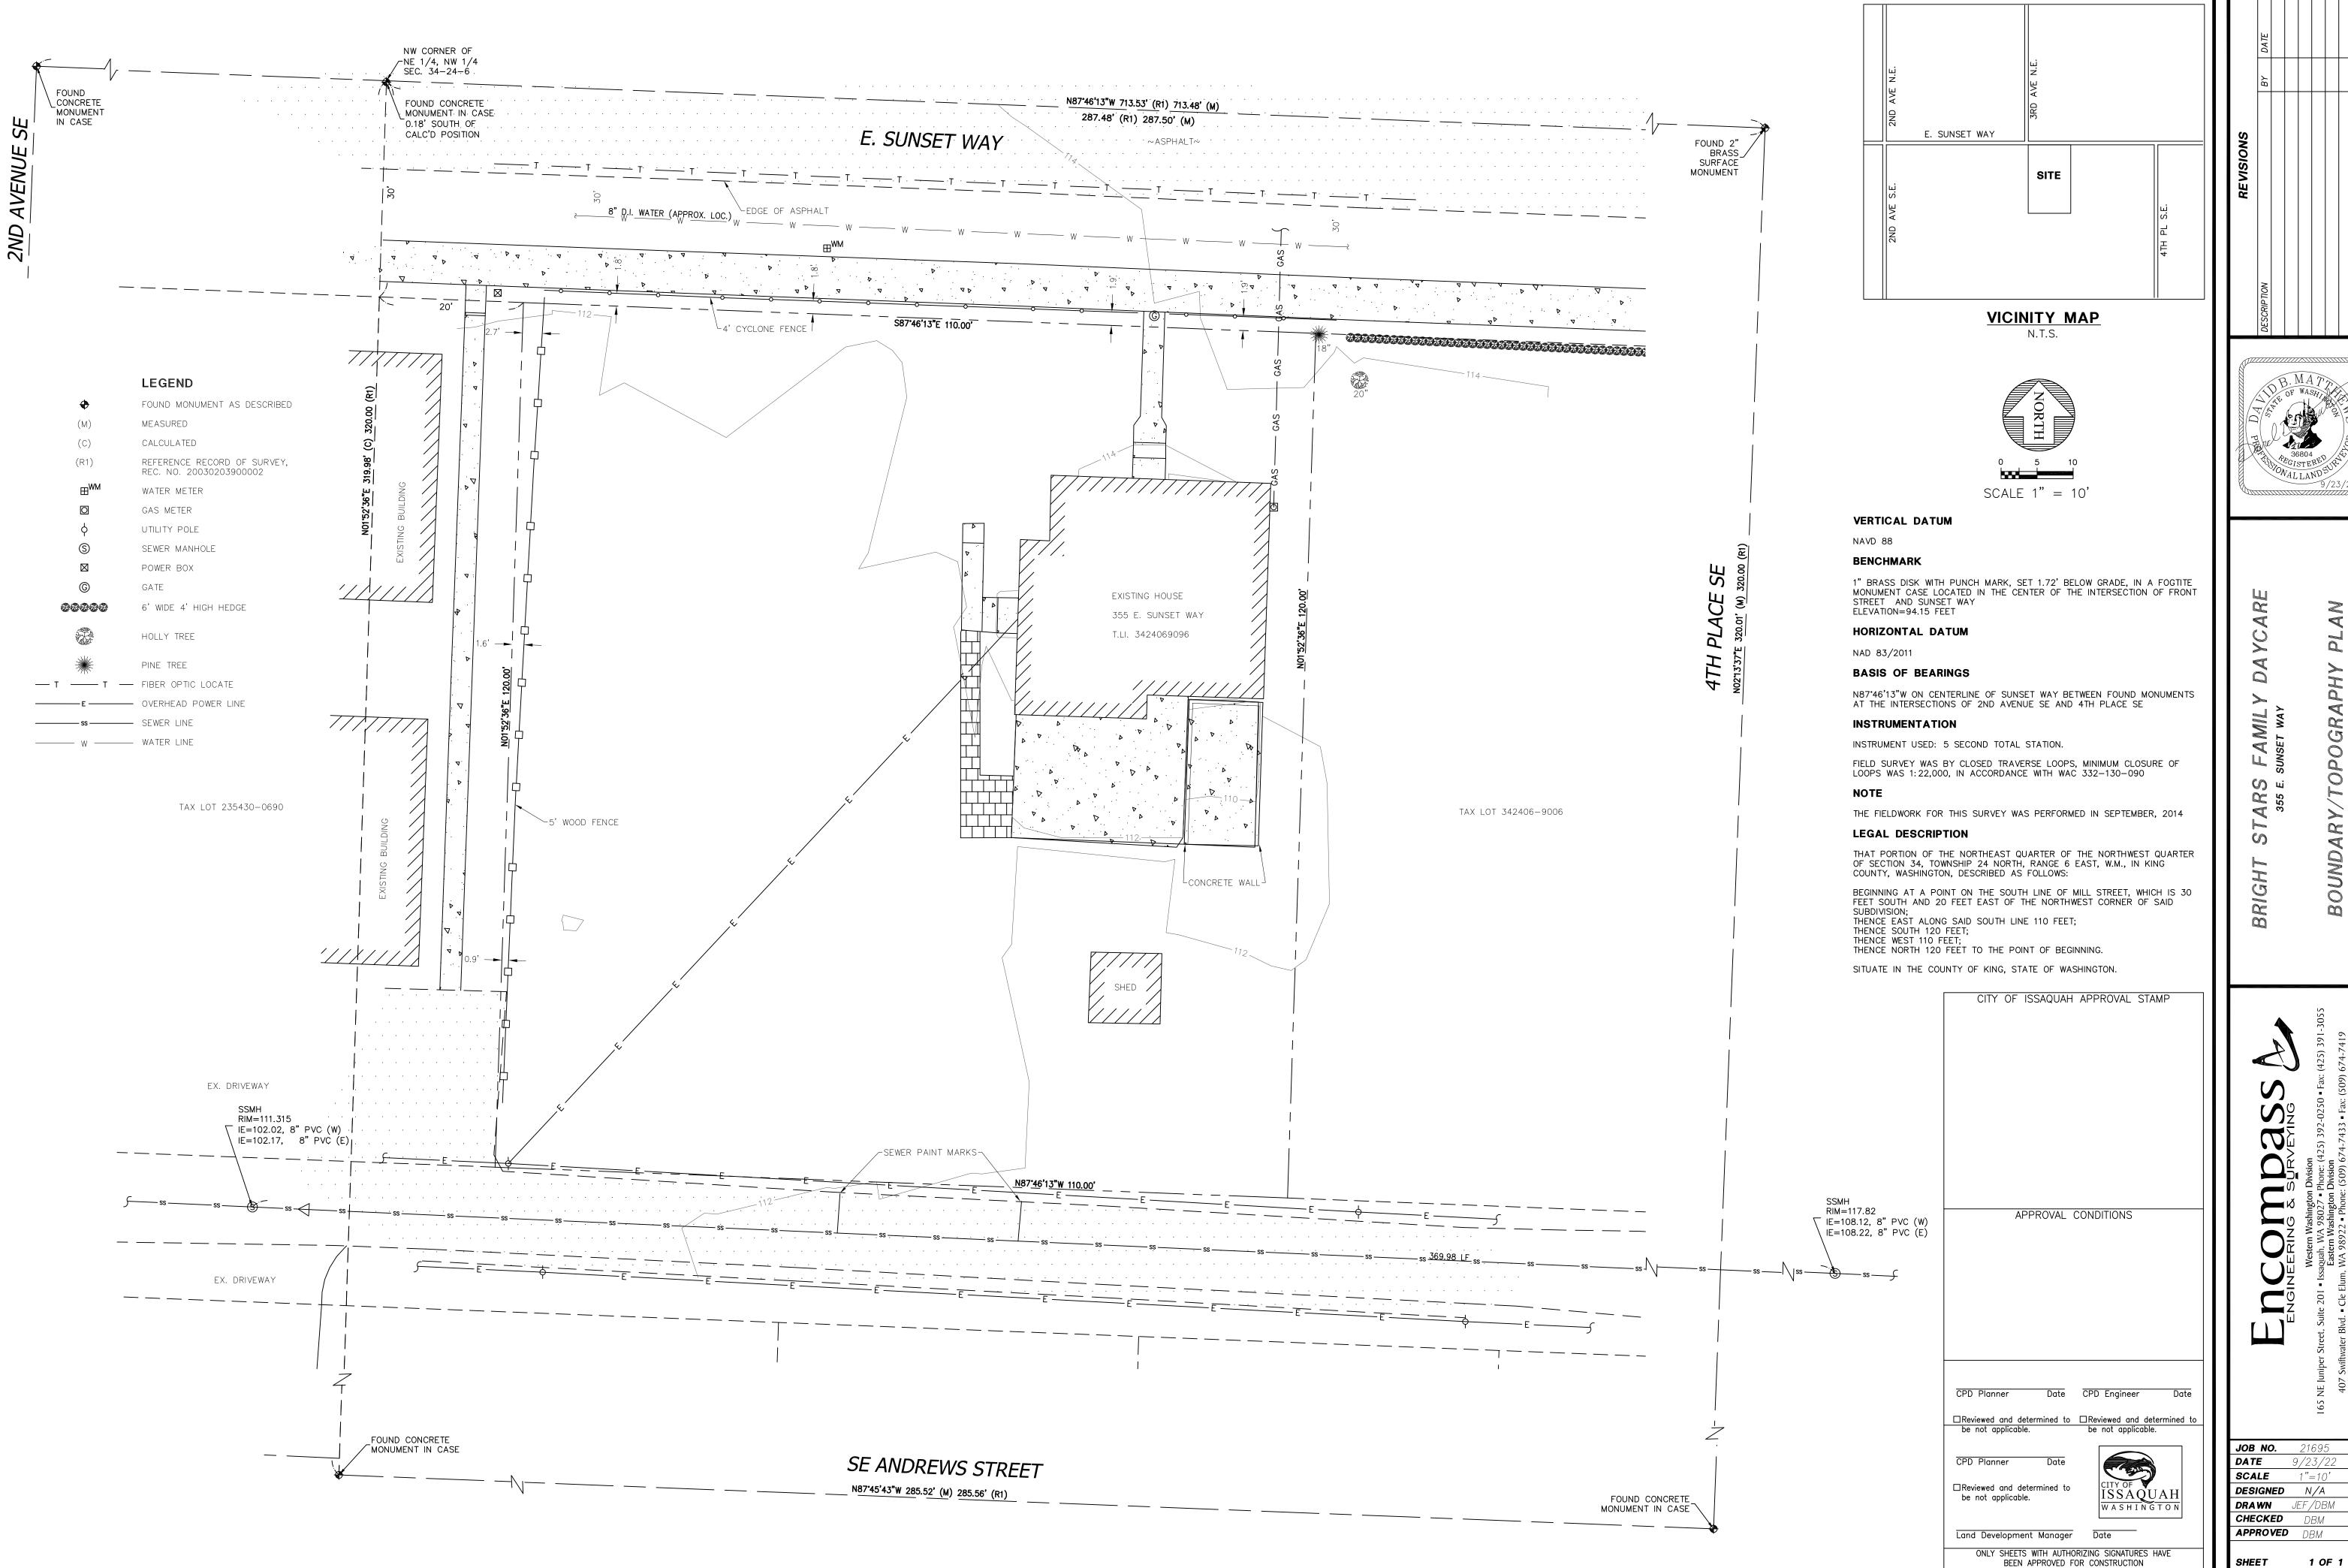
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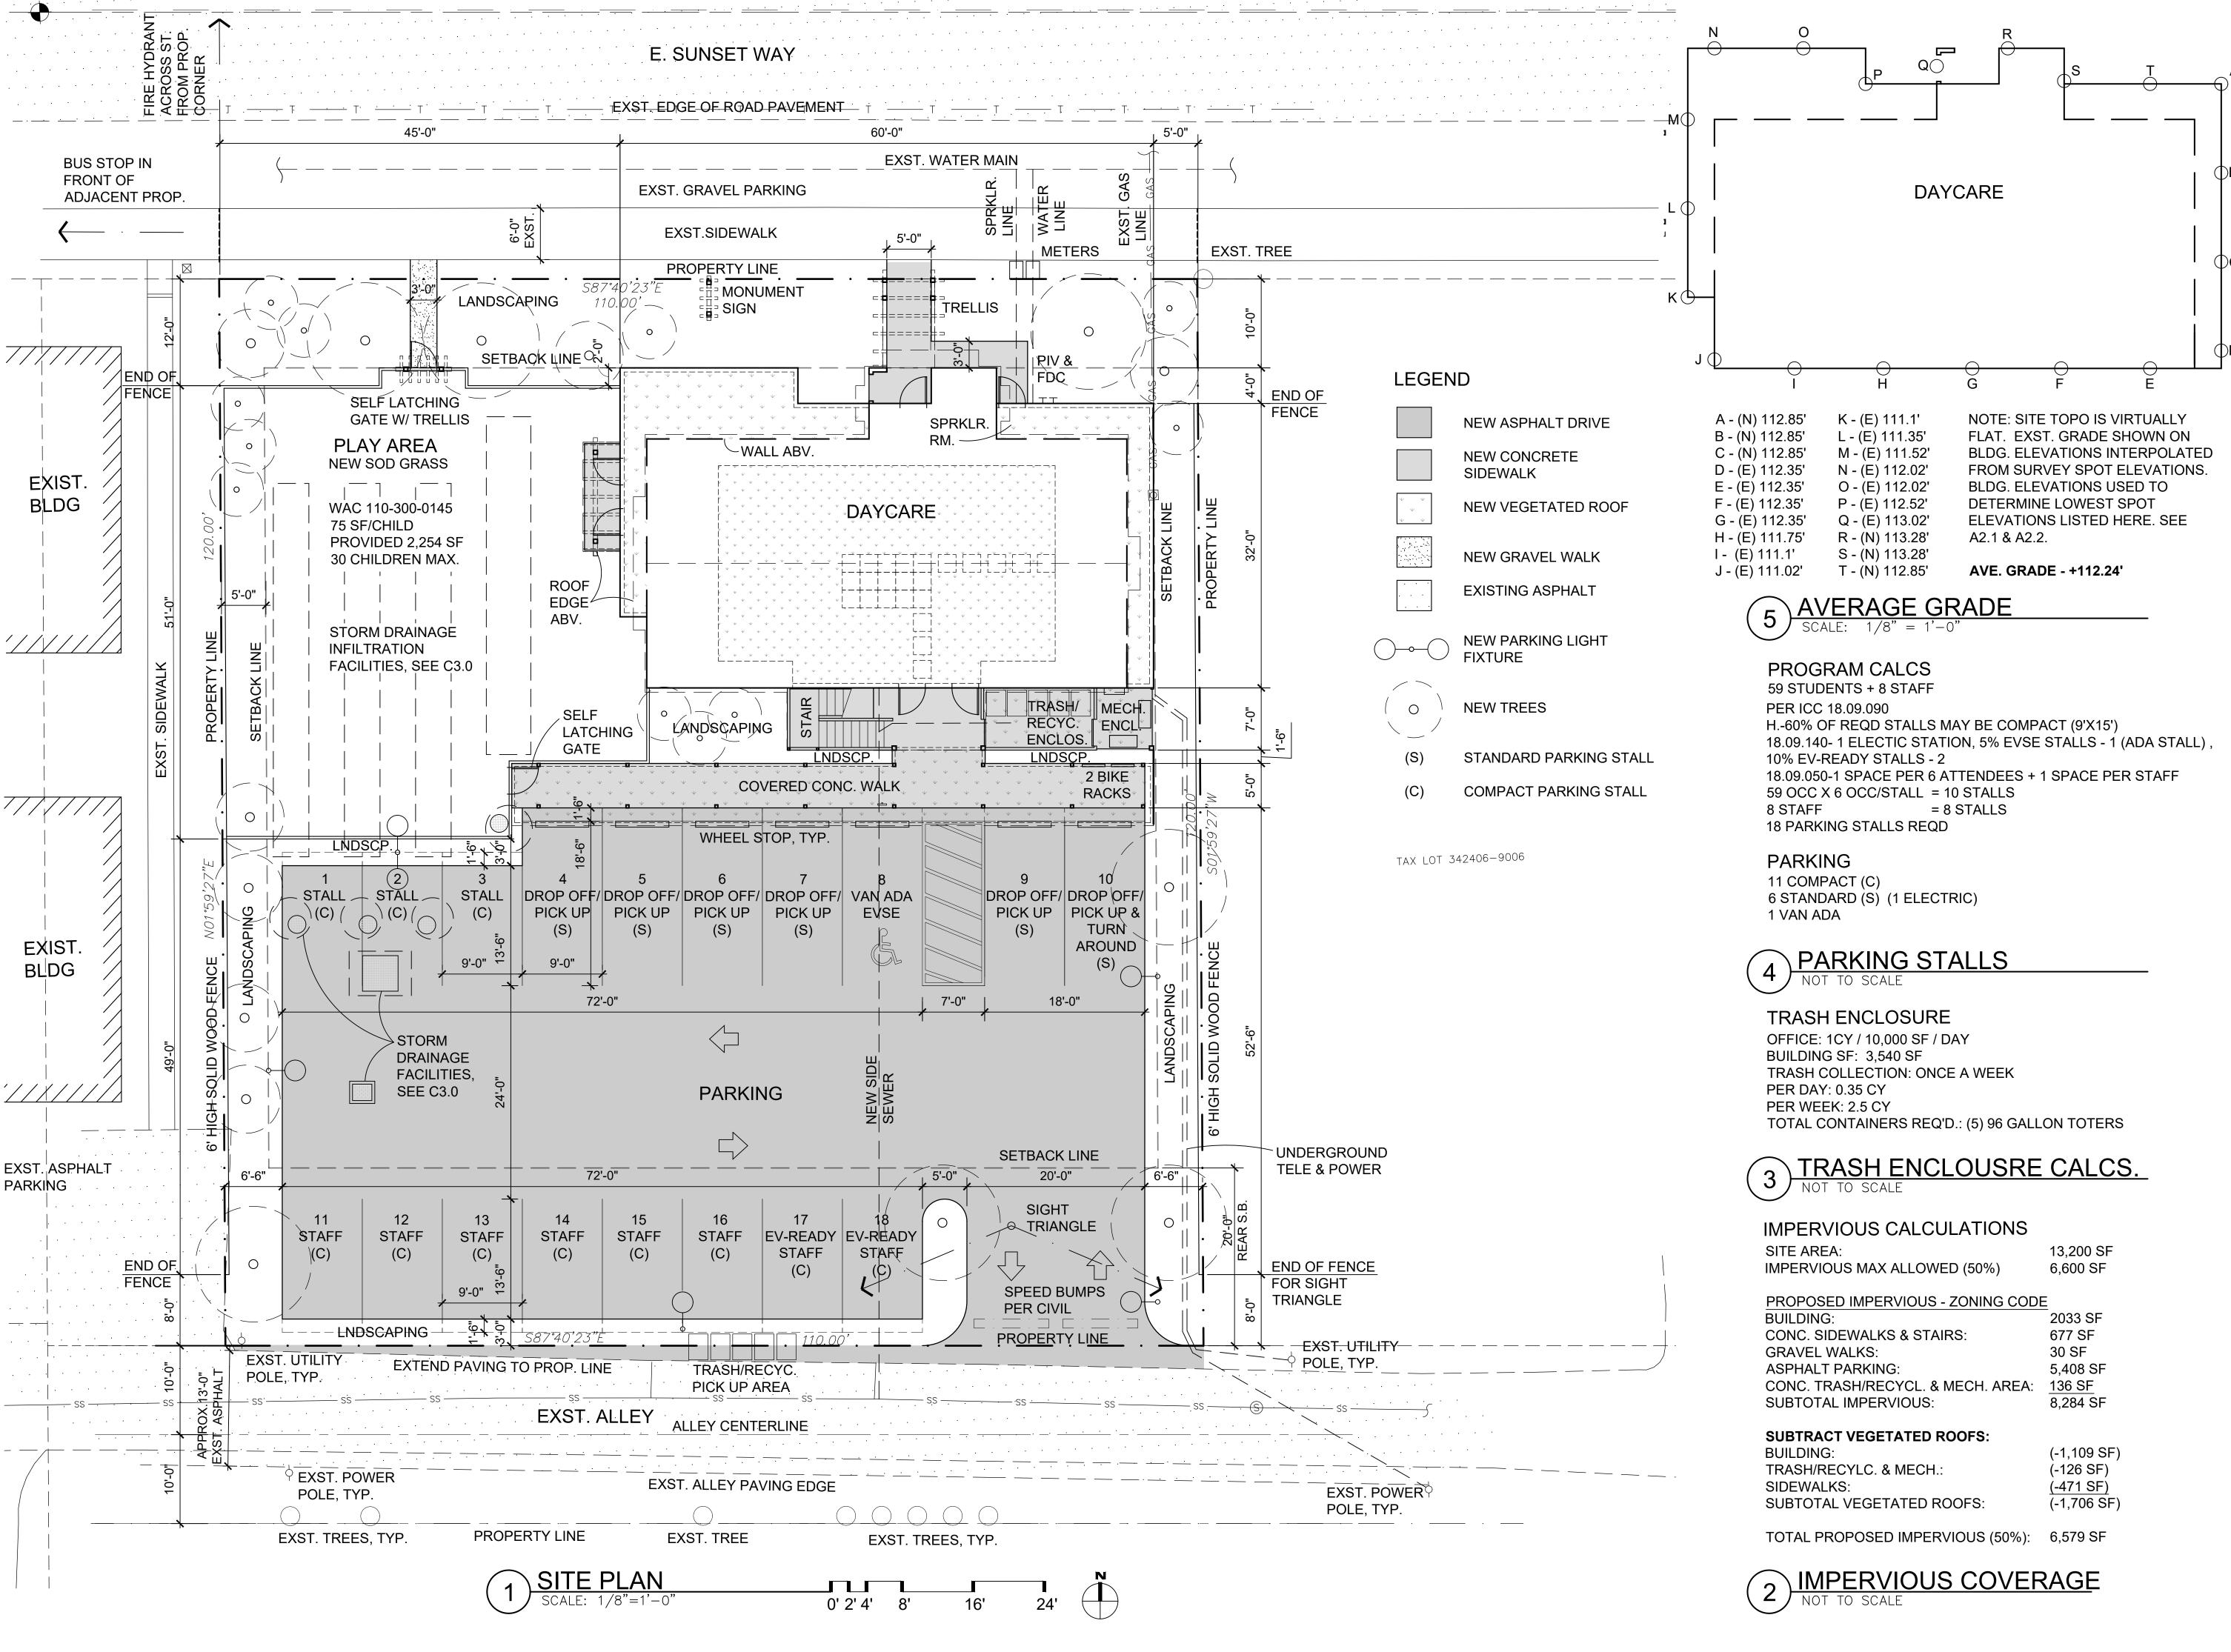
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 $\sqrt{2}$ TO CITY COMMENT

09 DECEMBER, 2022


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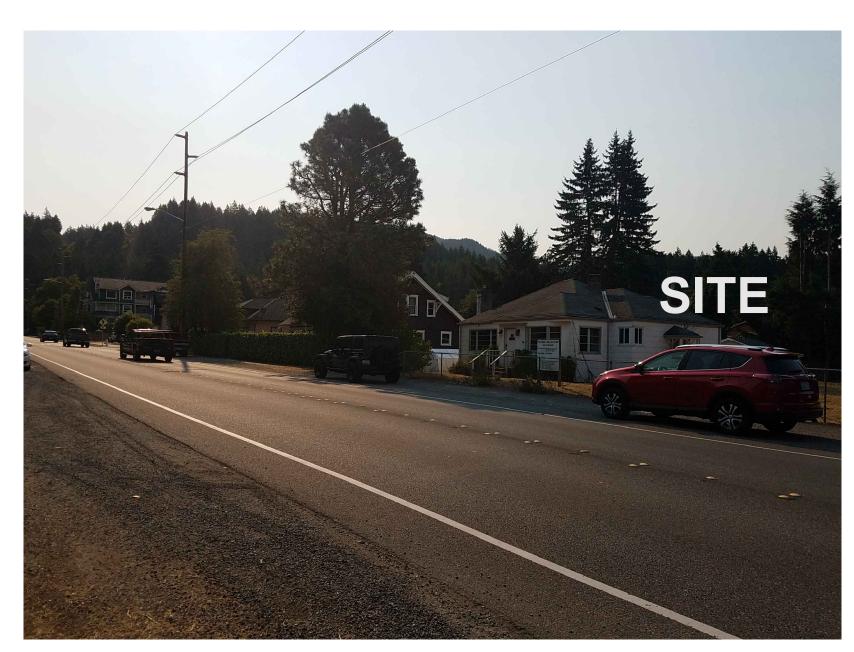
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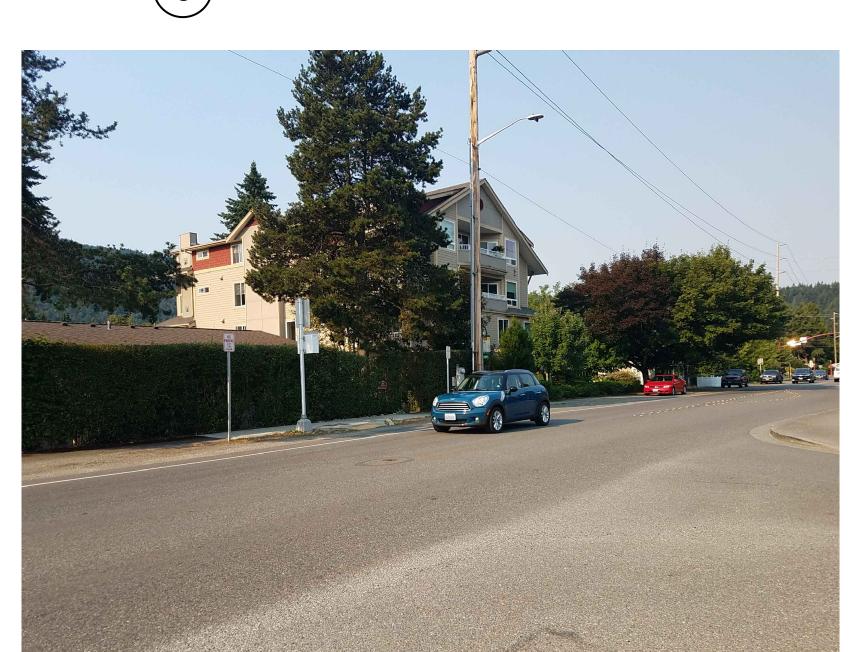
9/29/22 RESPONSE TO CITY COMMENT ↑ 12/09/22 RESPONSE $\sqrt{2}$ TO CITY COMMENT

09 DECEMBER, 2022 sheet title:

SITE PLAN SHEET



(3) E. SUNSET - LOOKING SE

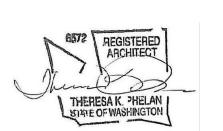

6 E. SUNSET - LOOKING WEST




9 ALLEY - LOOKING EAST




(2) E. SUNSET - LOOKING AT SITE



(5) E. SUNSET - LOOKING NE

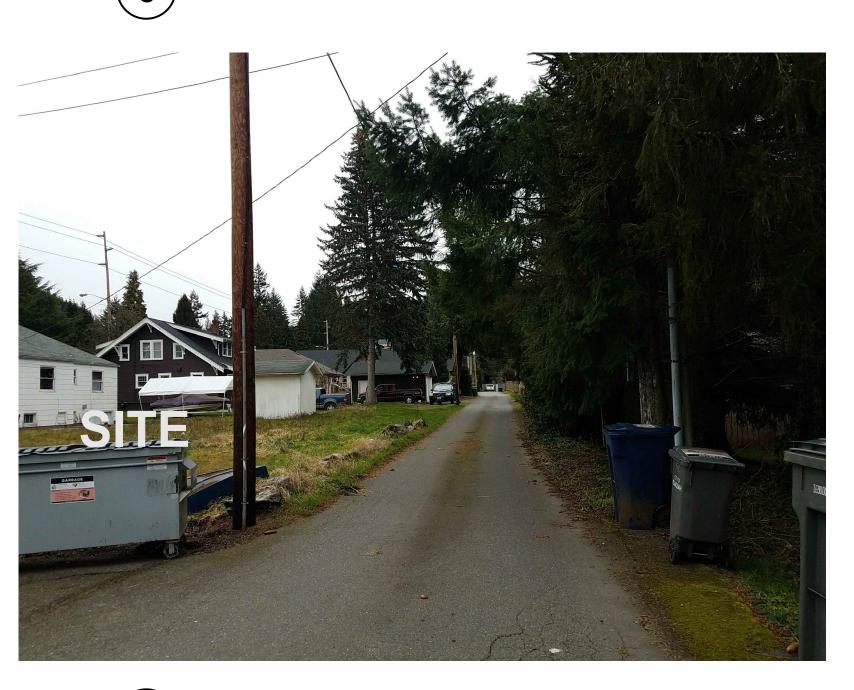

8 ALLEY - LOOKING EAST

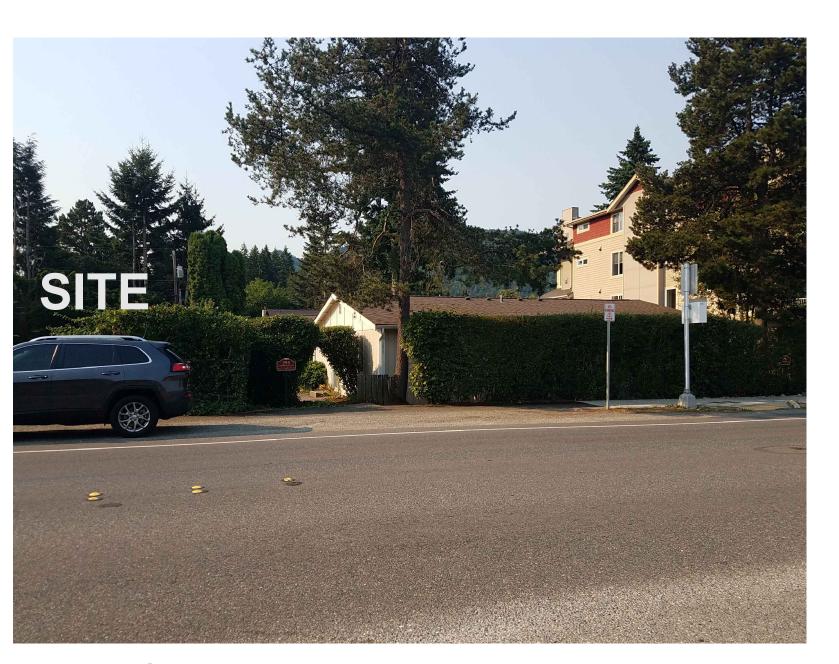

1 E. SUNSET - LOOKING SW



4 ALLEY - LOOKING WEST



7 ALLEY - LOOKING AT SITE



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file: 2019262.00
project name:
BRIGHT STARS
FAMILY
DAYCARE

owner:
THARAKA & DEEPTHI
DEVADITHYA
project address:
355 EAST SUNSET WAY

project address: 355 EAST SUNSET WAY ISSAQUAH, WA 98027

> ADMINISTRATIVE SITE DEVELOPMENT PERMIT

city approval stamp:

revision


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12/09/22 RESPONSE
TO CITY COMMENT

date: 09 DECEMBER, 2022

sheet title:
SITE
PHOTOS

sheet number:


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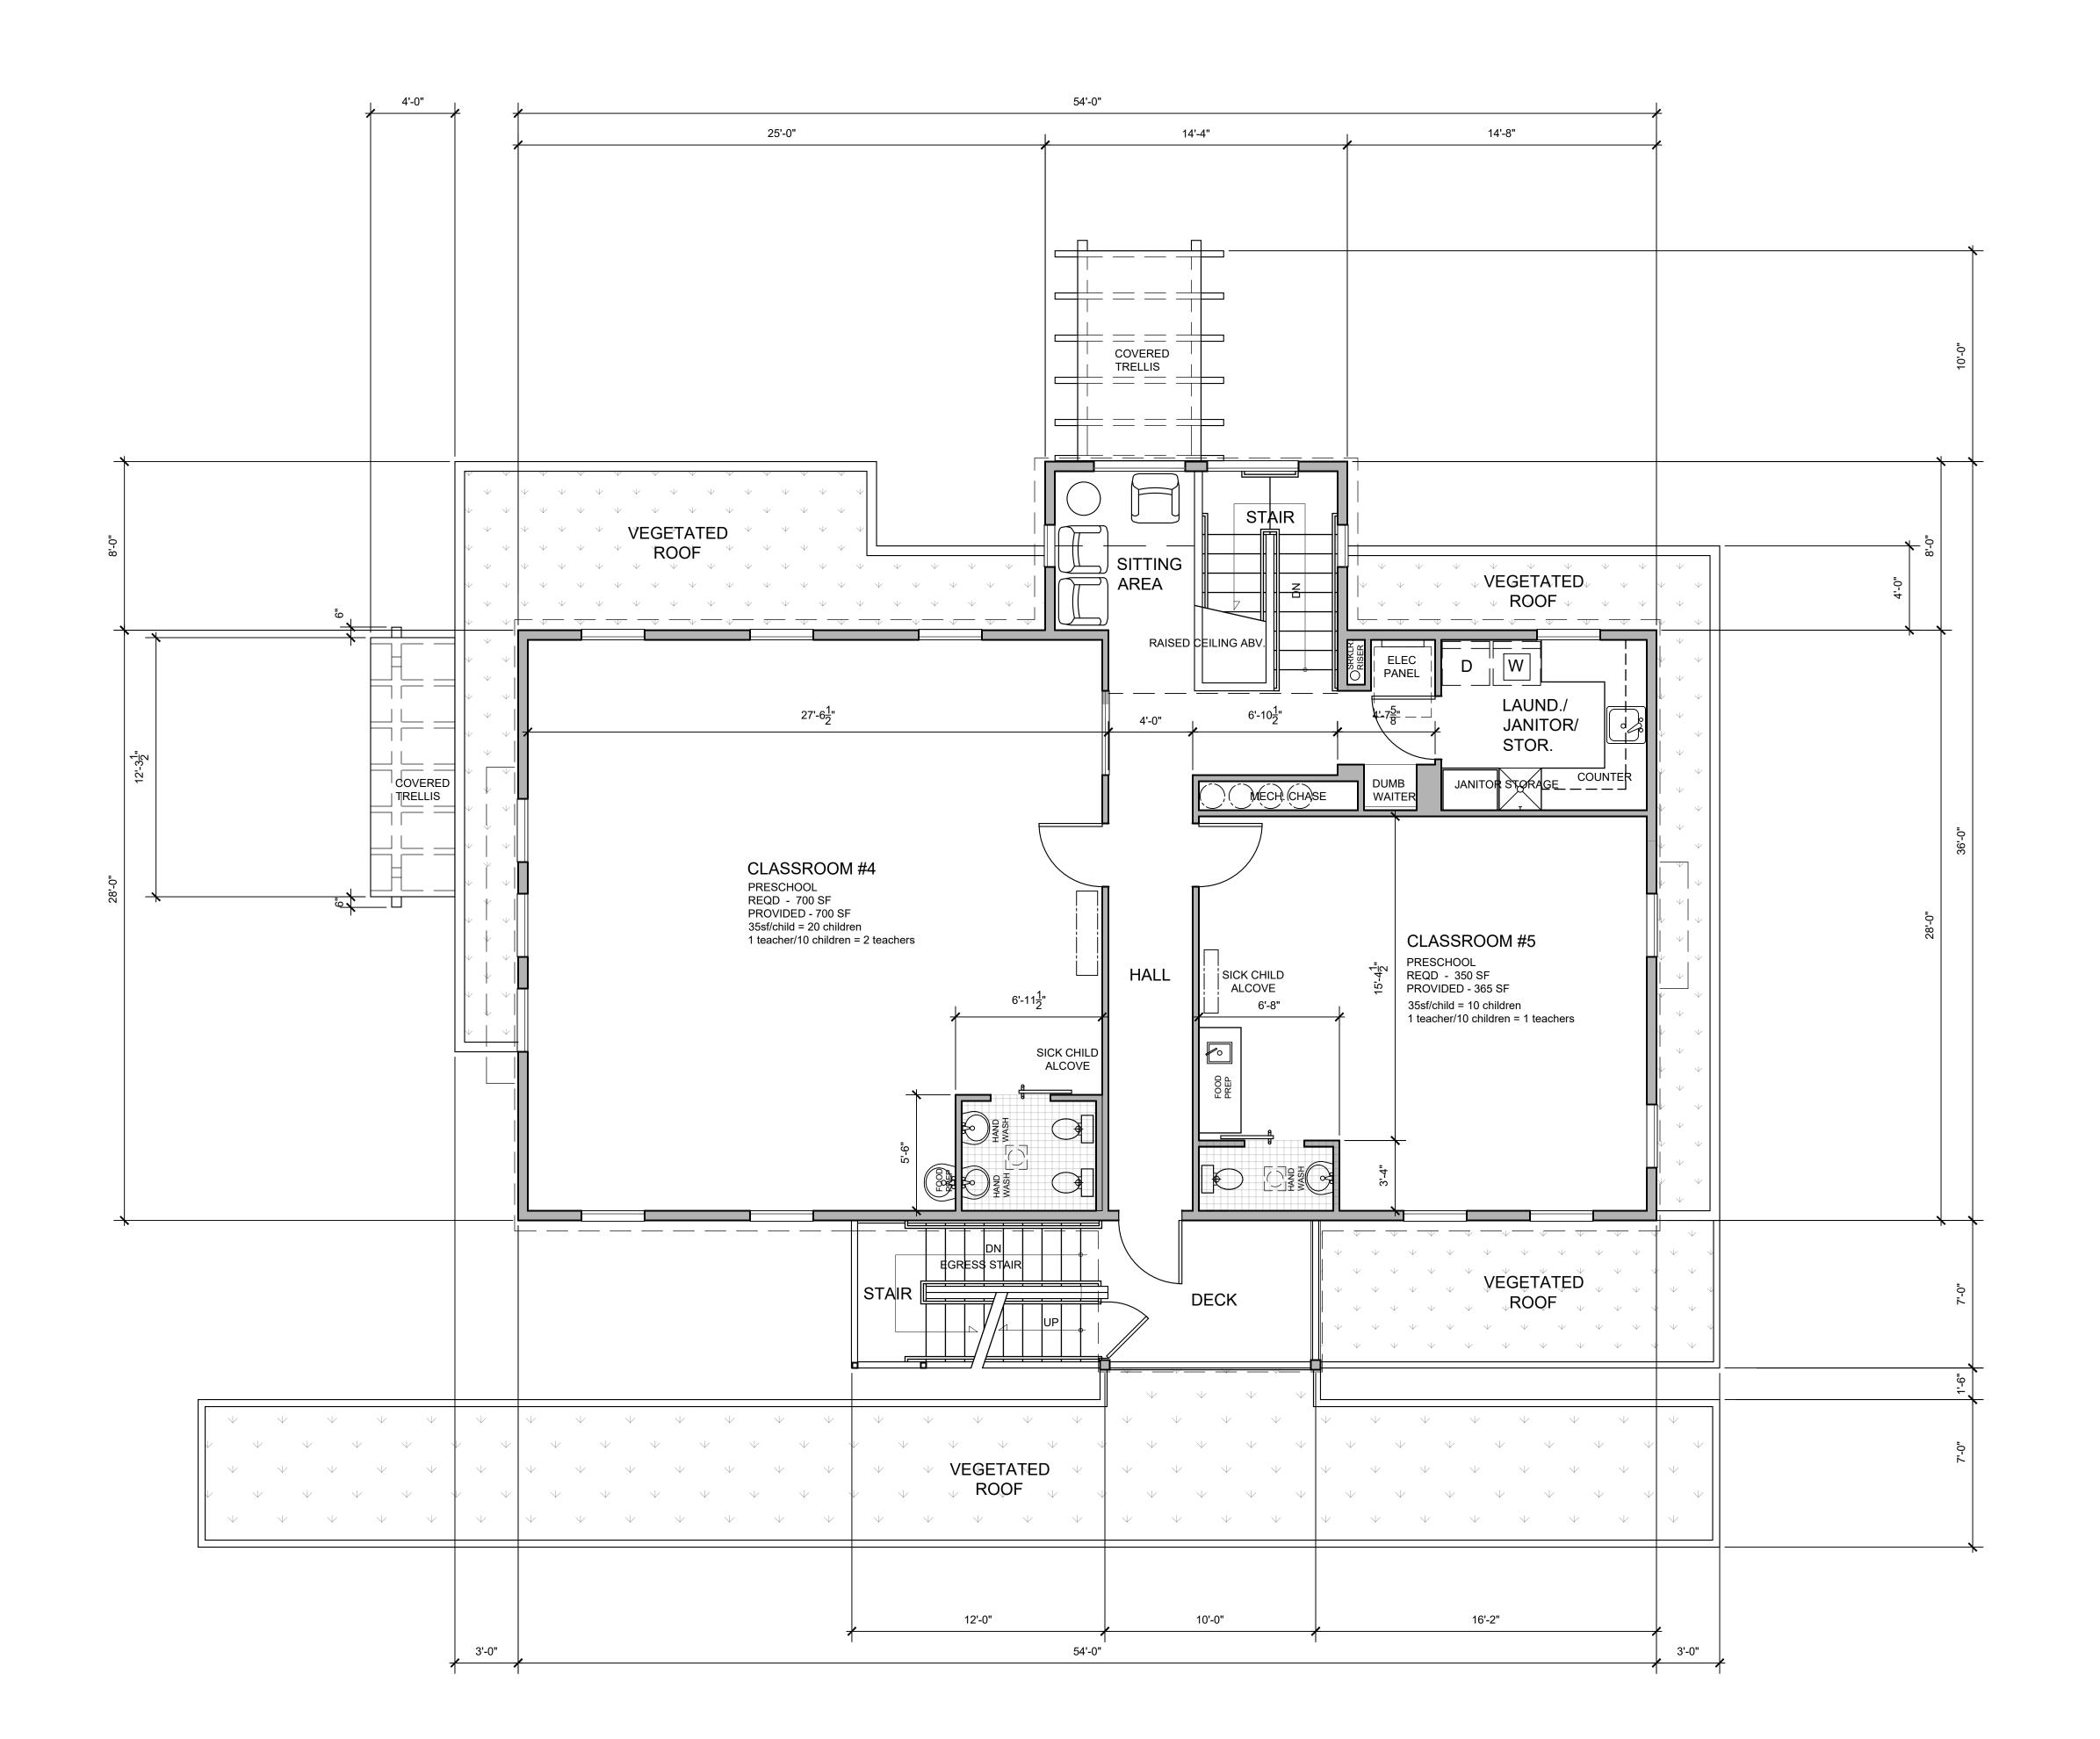
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TO CITY COMMENT

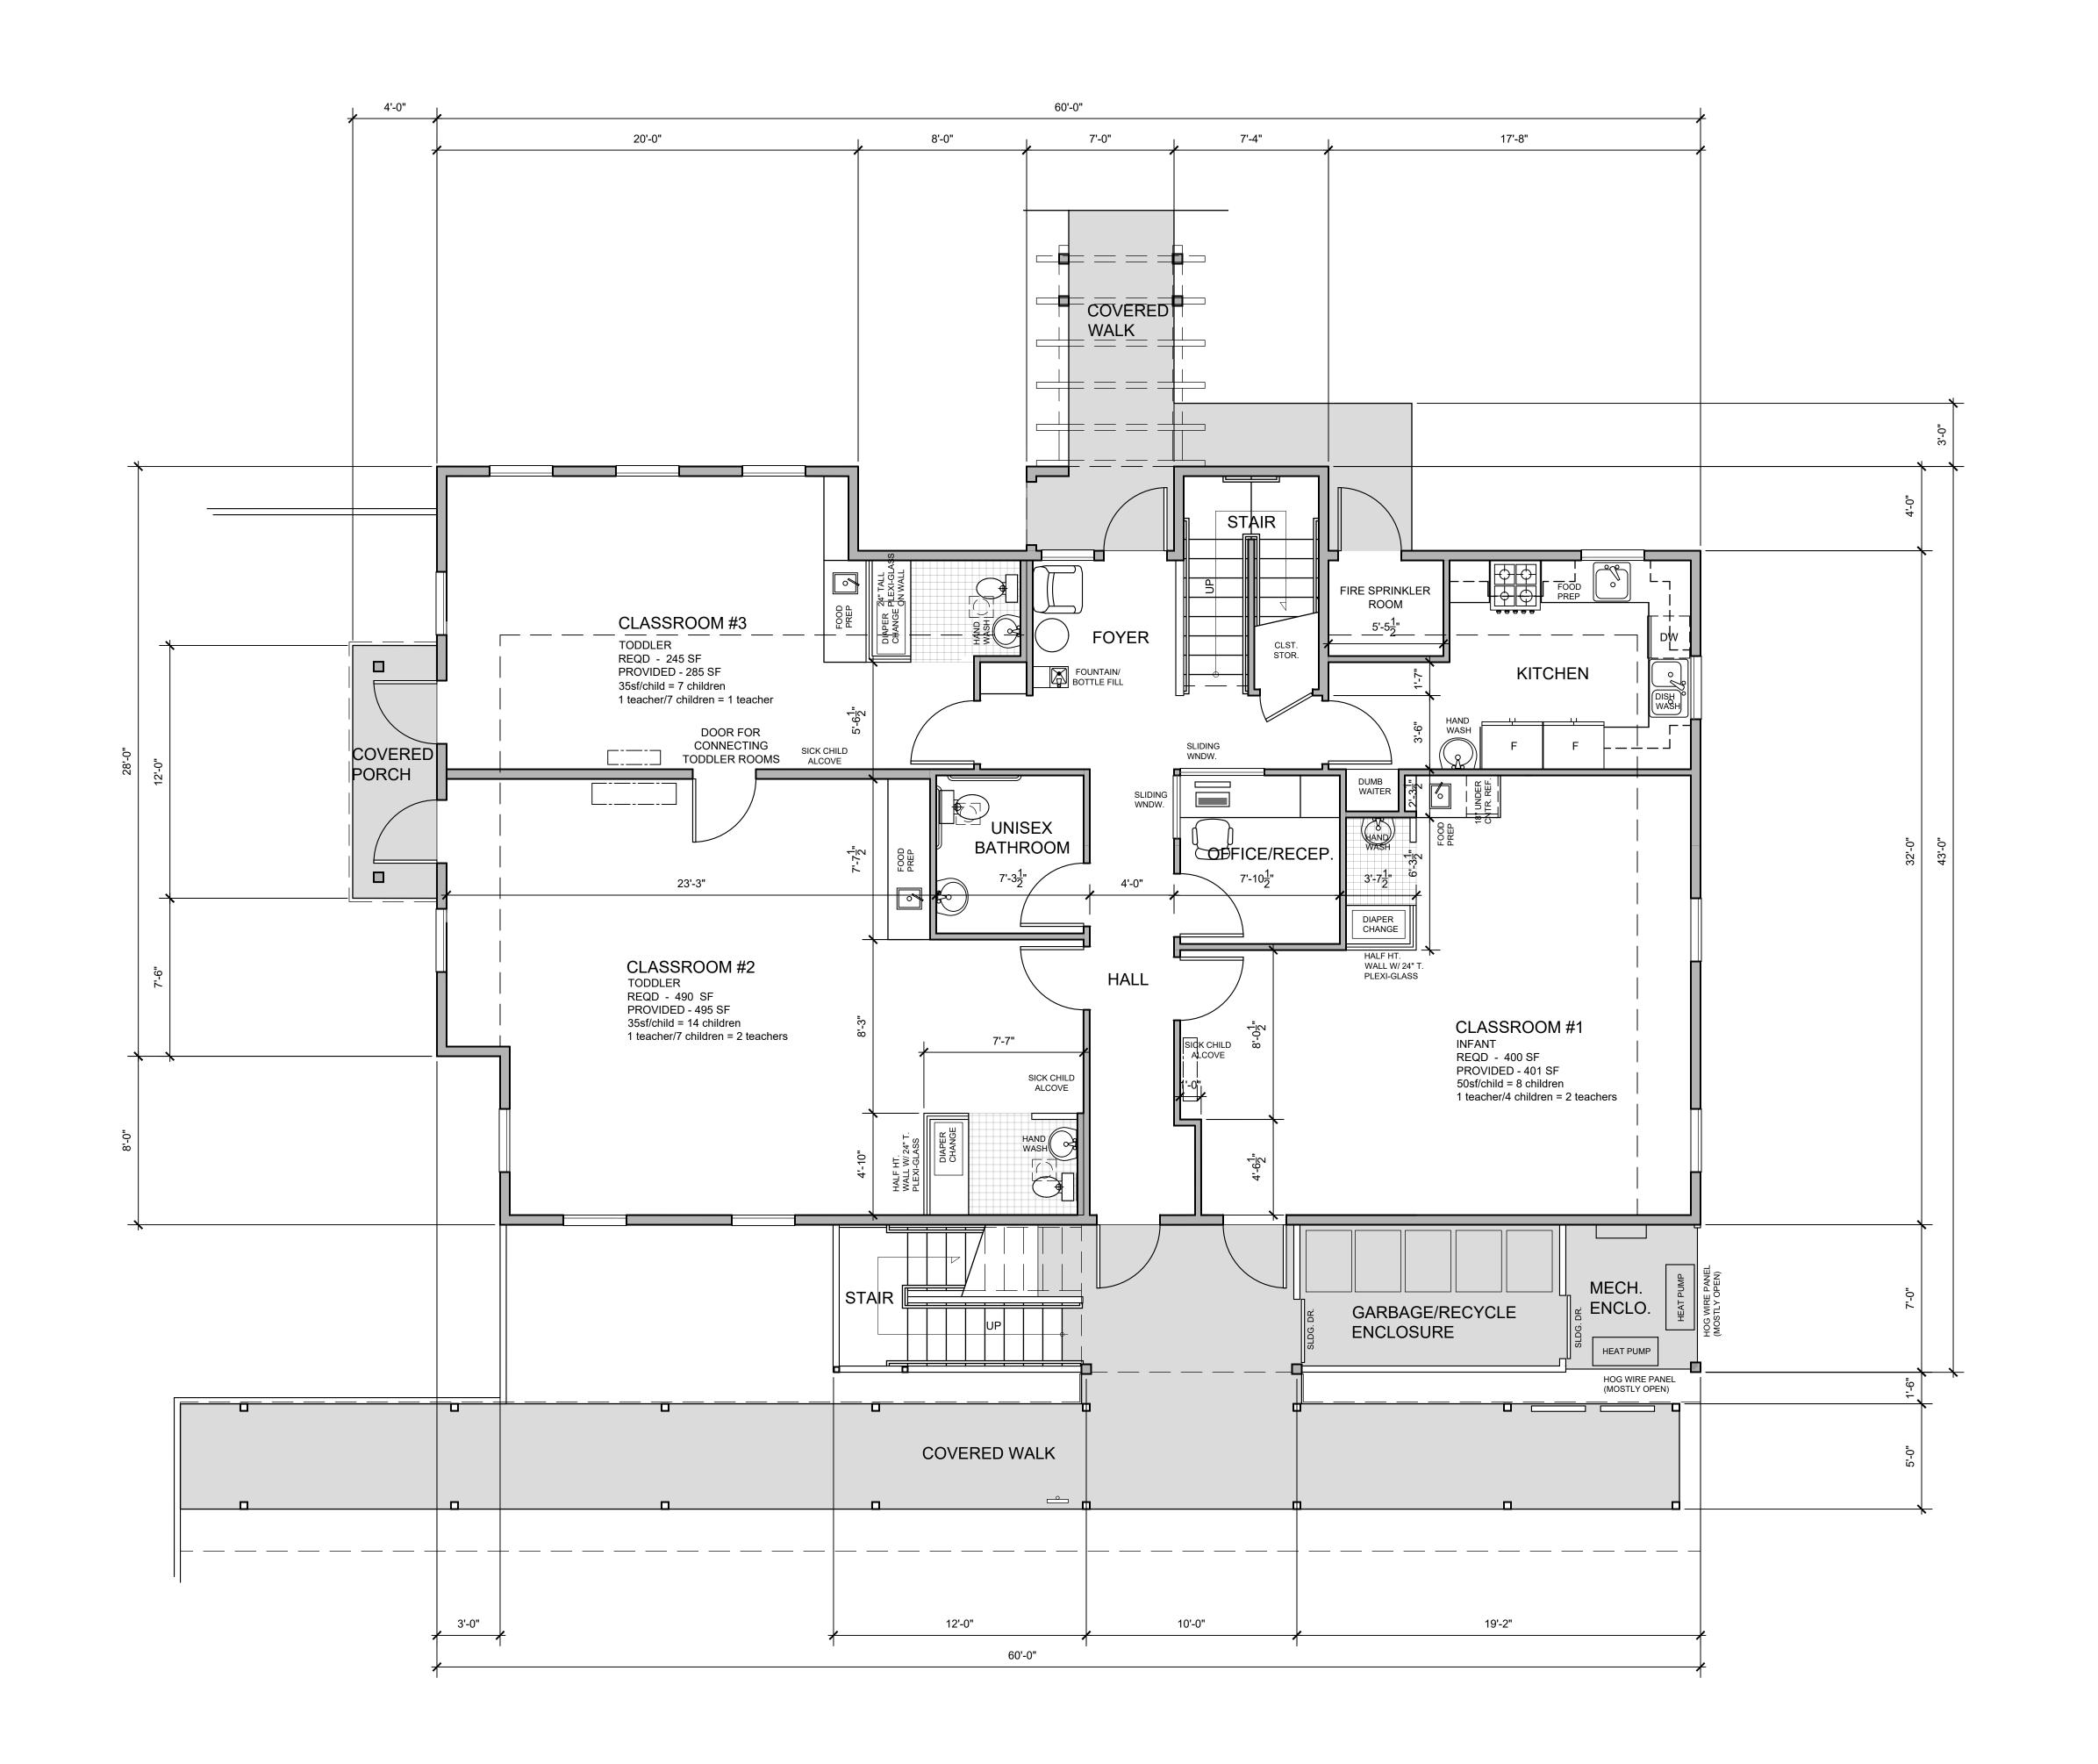09 DECEMBER, 2022

sheet title: GROUND FLOOR PLAN






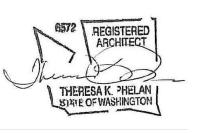

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owner:
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DEVADITHYA
project address:
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12/09/22 RESPONSE
TO CITY COMMENT


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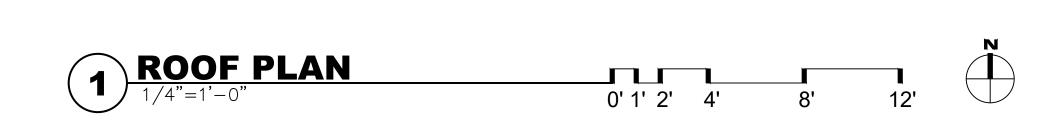
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UPPER FLOOR PLAN

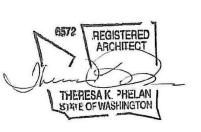sheet number:

A1.2





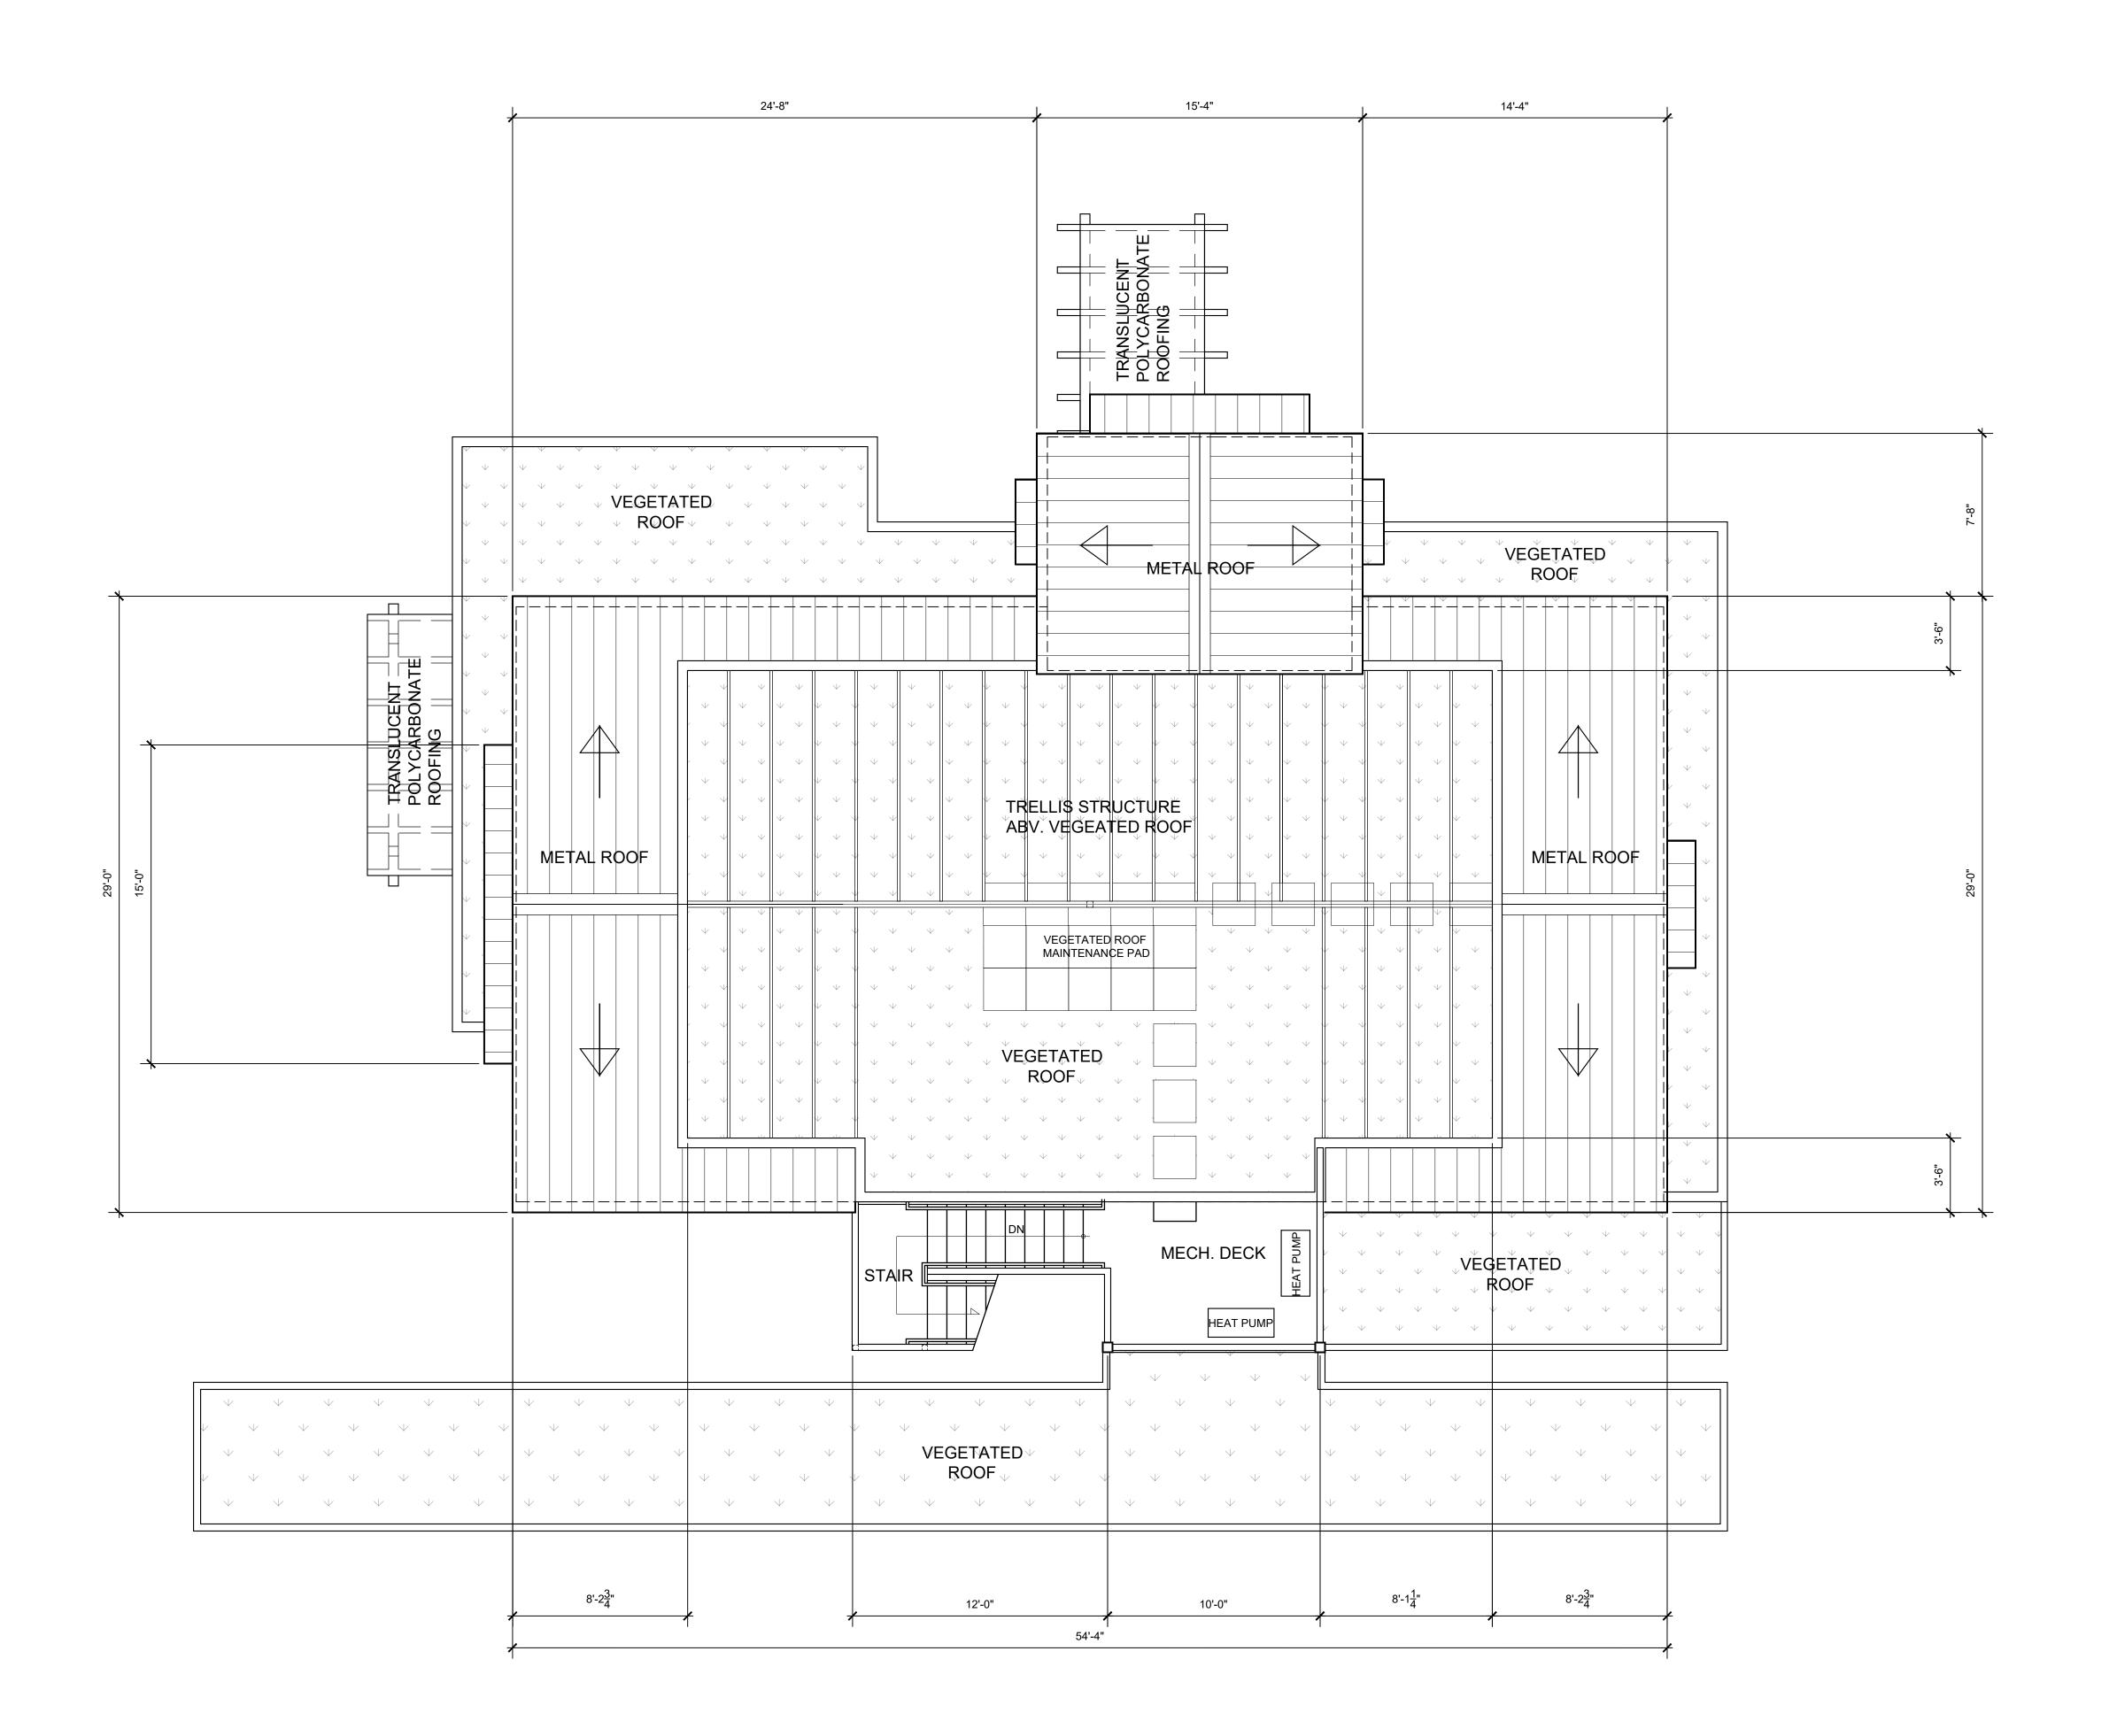

SUITE 100

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THERESA K. PHELAN STATE OF WASHINGTON

SEATTLE, WA 98112

file: 2019262.00
project name:
BRIGHT STARS
FAMILY
DAYCARE

owner:
THARAKA & DEEPTHI
DEVADITHYA
project address:

project address: 355 EAST SUNSET WAY ISSAQUAH, WA 98027

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city approval stamp:

revisions:

9/29/22 RESPONSE
TO CITY COMMENT
12/09/22 RESPONSE
TO CITY COMMENT

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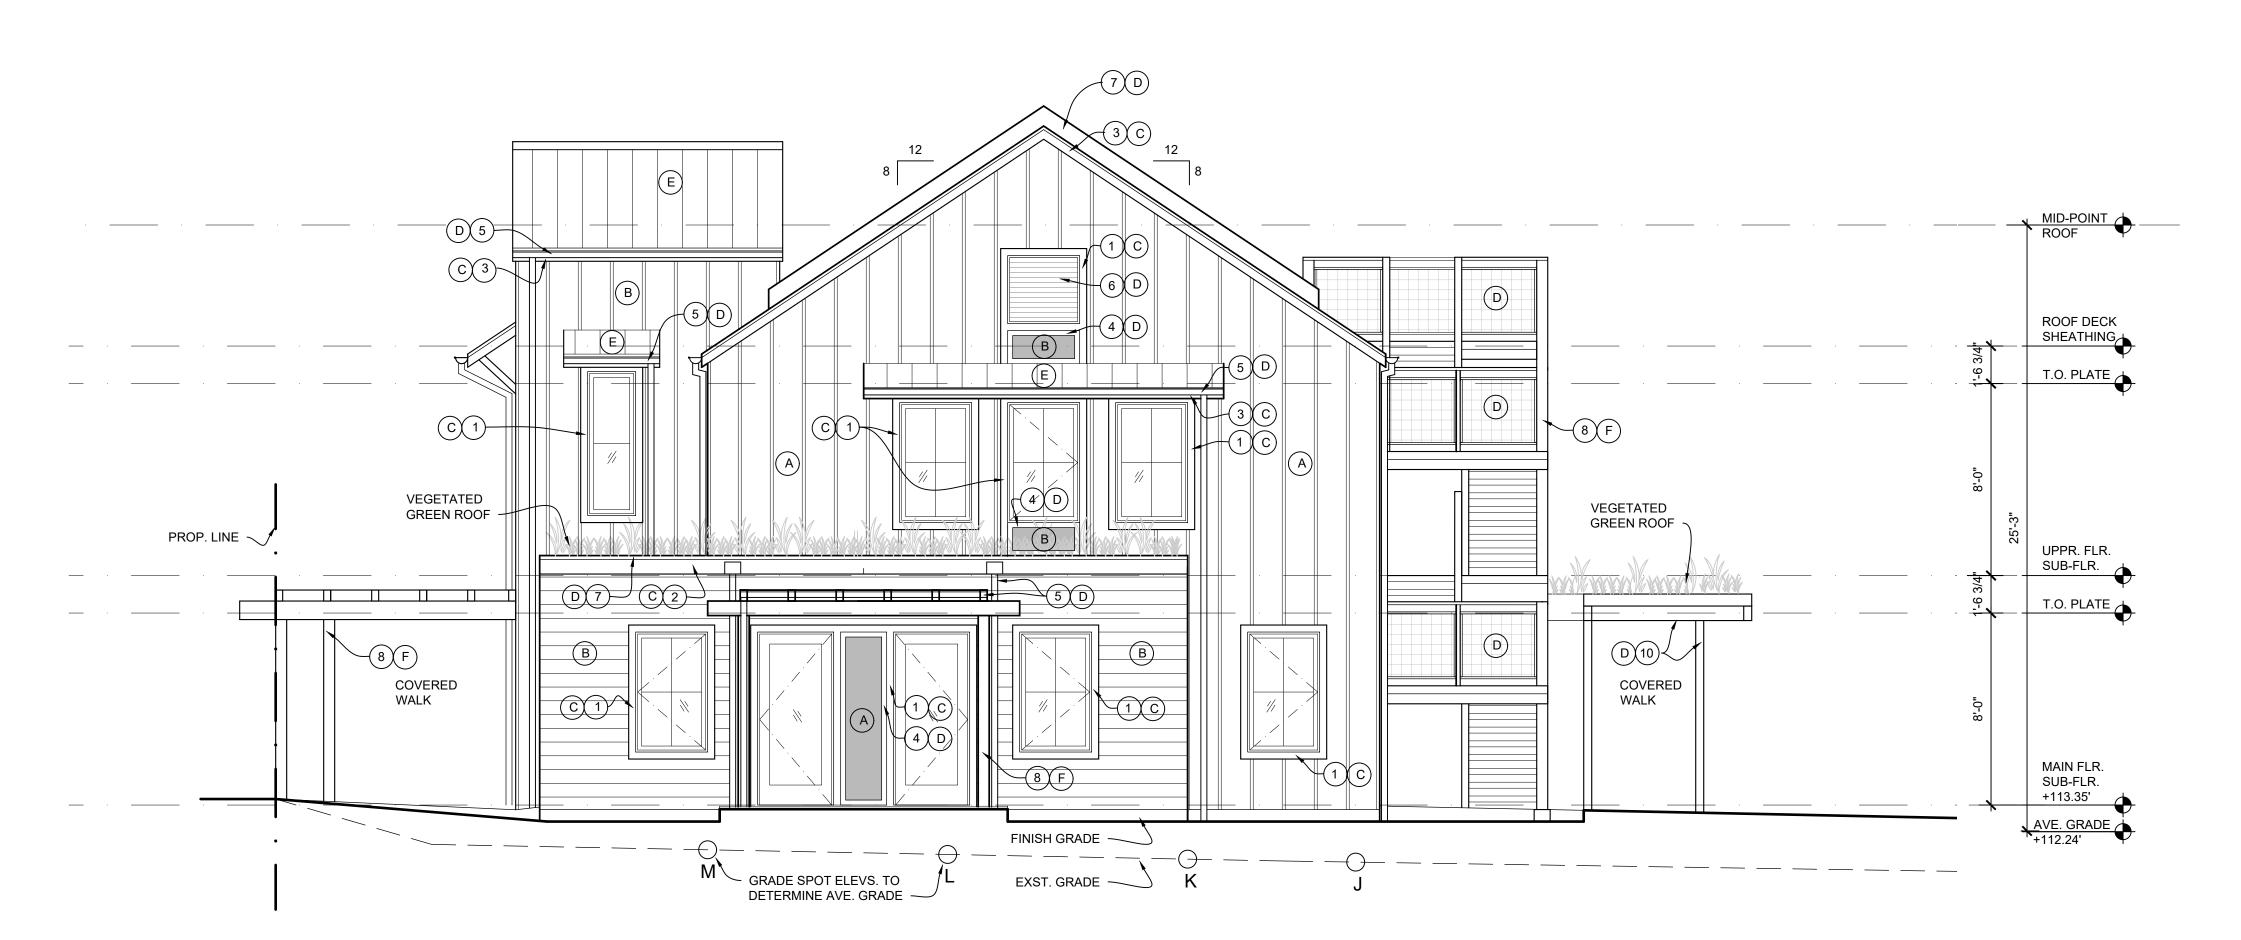
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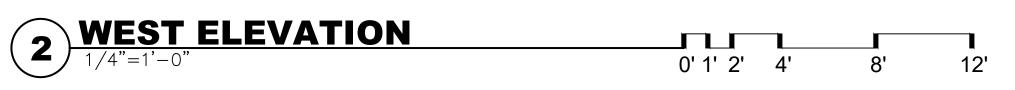
sheet title:
ROOF PLAN

sheet number:


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file: **2019262.00** project name: **BRIGHT STARS FAMILY** DAYCARE

THARAKA & DEEPTHI DEVADITHYA

project address: 355 EAST SUNSET WAY ISSAQUAH, WA 98027

ADMINISTRATIVE SITE DEVELOPMENT PERMIT

LEGEND - MATERIALS

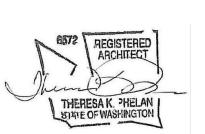HARDIE WOODGRAIN LAP SIDING 7 1/4" WIDTH, 6" EXPOSURE

BOARD - HARDIE WOODGRAIN PANEL

BATTEN - PREPRIMED WHITE SPRUCE BATTEN BOARDS 3/4" X 1 1/2" @ 16" OC.

2"X4" METAL WELDED WIRE GRID GUARD (NOT TO ALLOW 4" SPHERE TO PASS THROUGH)

WINDOW & DOOR TRIM - PREPRIMED WHITE SPRUCE 1" X 3 1/2" OR SIM.

GREEN ROOF PARAPET - PREPRIMED WHITE SPRUCE 1" X 9 1/4" OR SIM.

ROOF EDGE TRIM - PREPRIMED

WHITE SPRUCE 1" X 5 1/2" OR SIM.

PREPRIMED WHITE SPRUCE 3/4" X

GUTTERS, COLLECTOR HEADS &

HARDI PANEL SMOOTH VERTICAL SIDING 4' WIDE

VERTICAL SIDING 4' WIDE;

METAL STANDING SEAM

WINDOW FRAME &

GLAZING

2 1/2" OR SIM.

DOWNSPOUTS

ATTIC LOUVERED VENT

SHEET METAL COPING

CEDAR WOOD TRELLIS

RAFTERS & BEAM TRELLIS, WOOD OR METAL TBD

TUBE STEEL STRUCTURE

VIRTUAL TAUPE, SW 7039

URBANE BRONZE, SW 7048

TRICORN BLACK, SW 6258

CLEAR STAIN

EVERGREEN, KINGSPAN 'MORIN'

SMOKEHOUSE, SW 7040

LEGEND - COLORS

В


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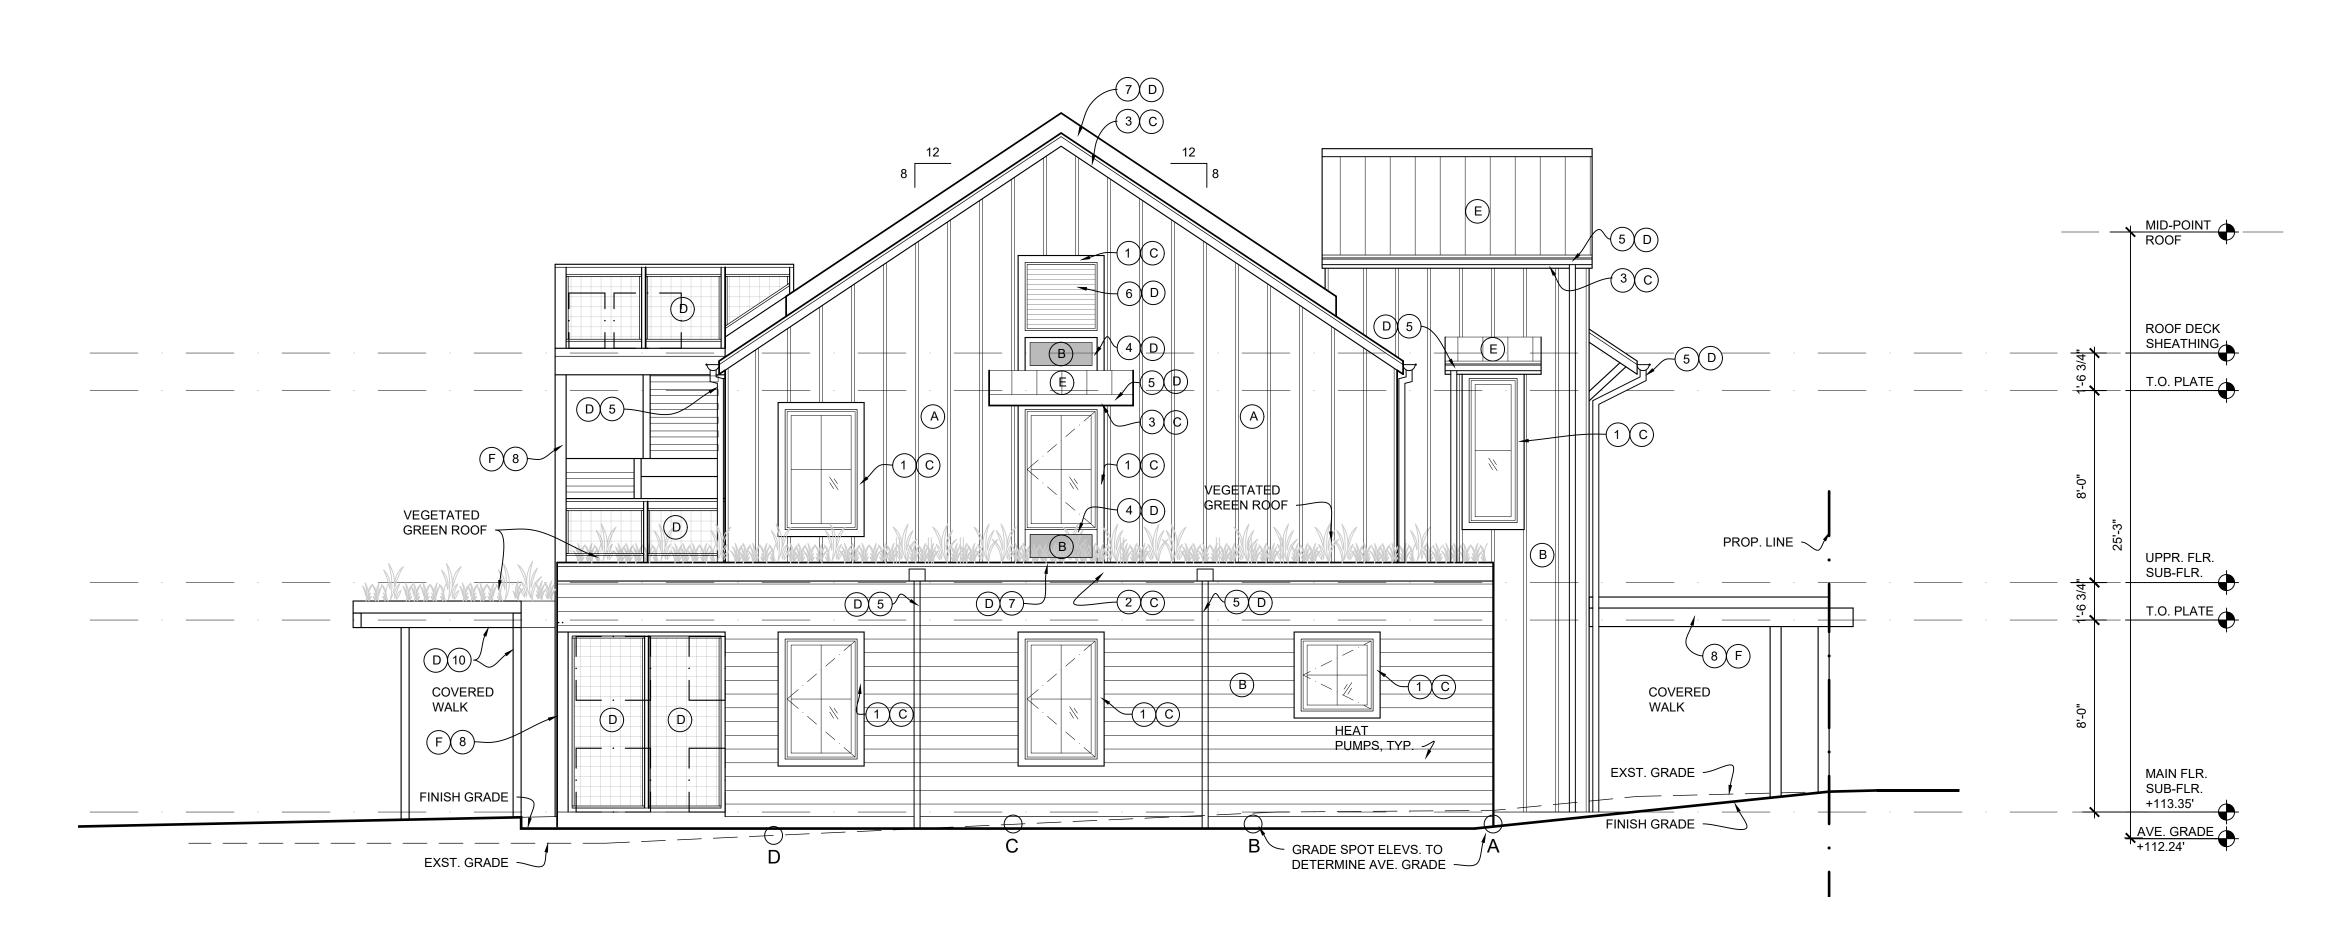
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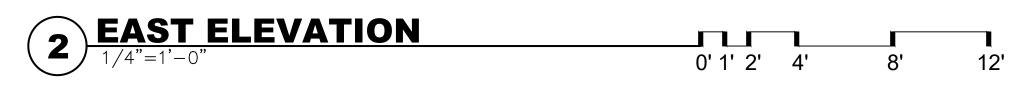
∆ 9/29/22 RESPONSE 1 TO CITY COMMENT ↑ 12/09/22 RESPONSE $\sqrt{2}$ TO CITY COMMENT

09 DECEMBER, 2022 sheet title:

NORTH & WEST **ELEVATIONS**





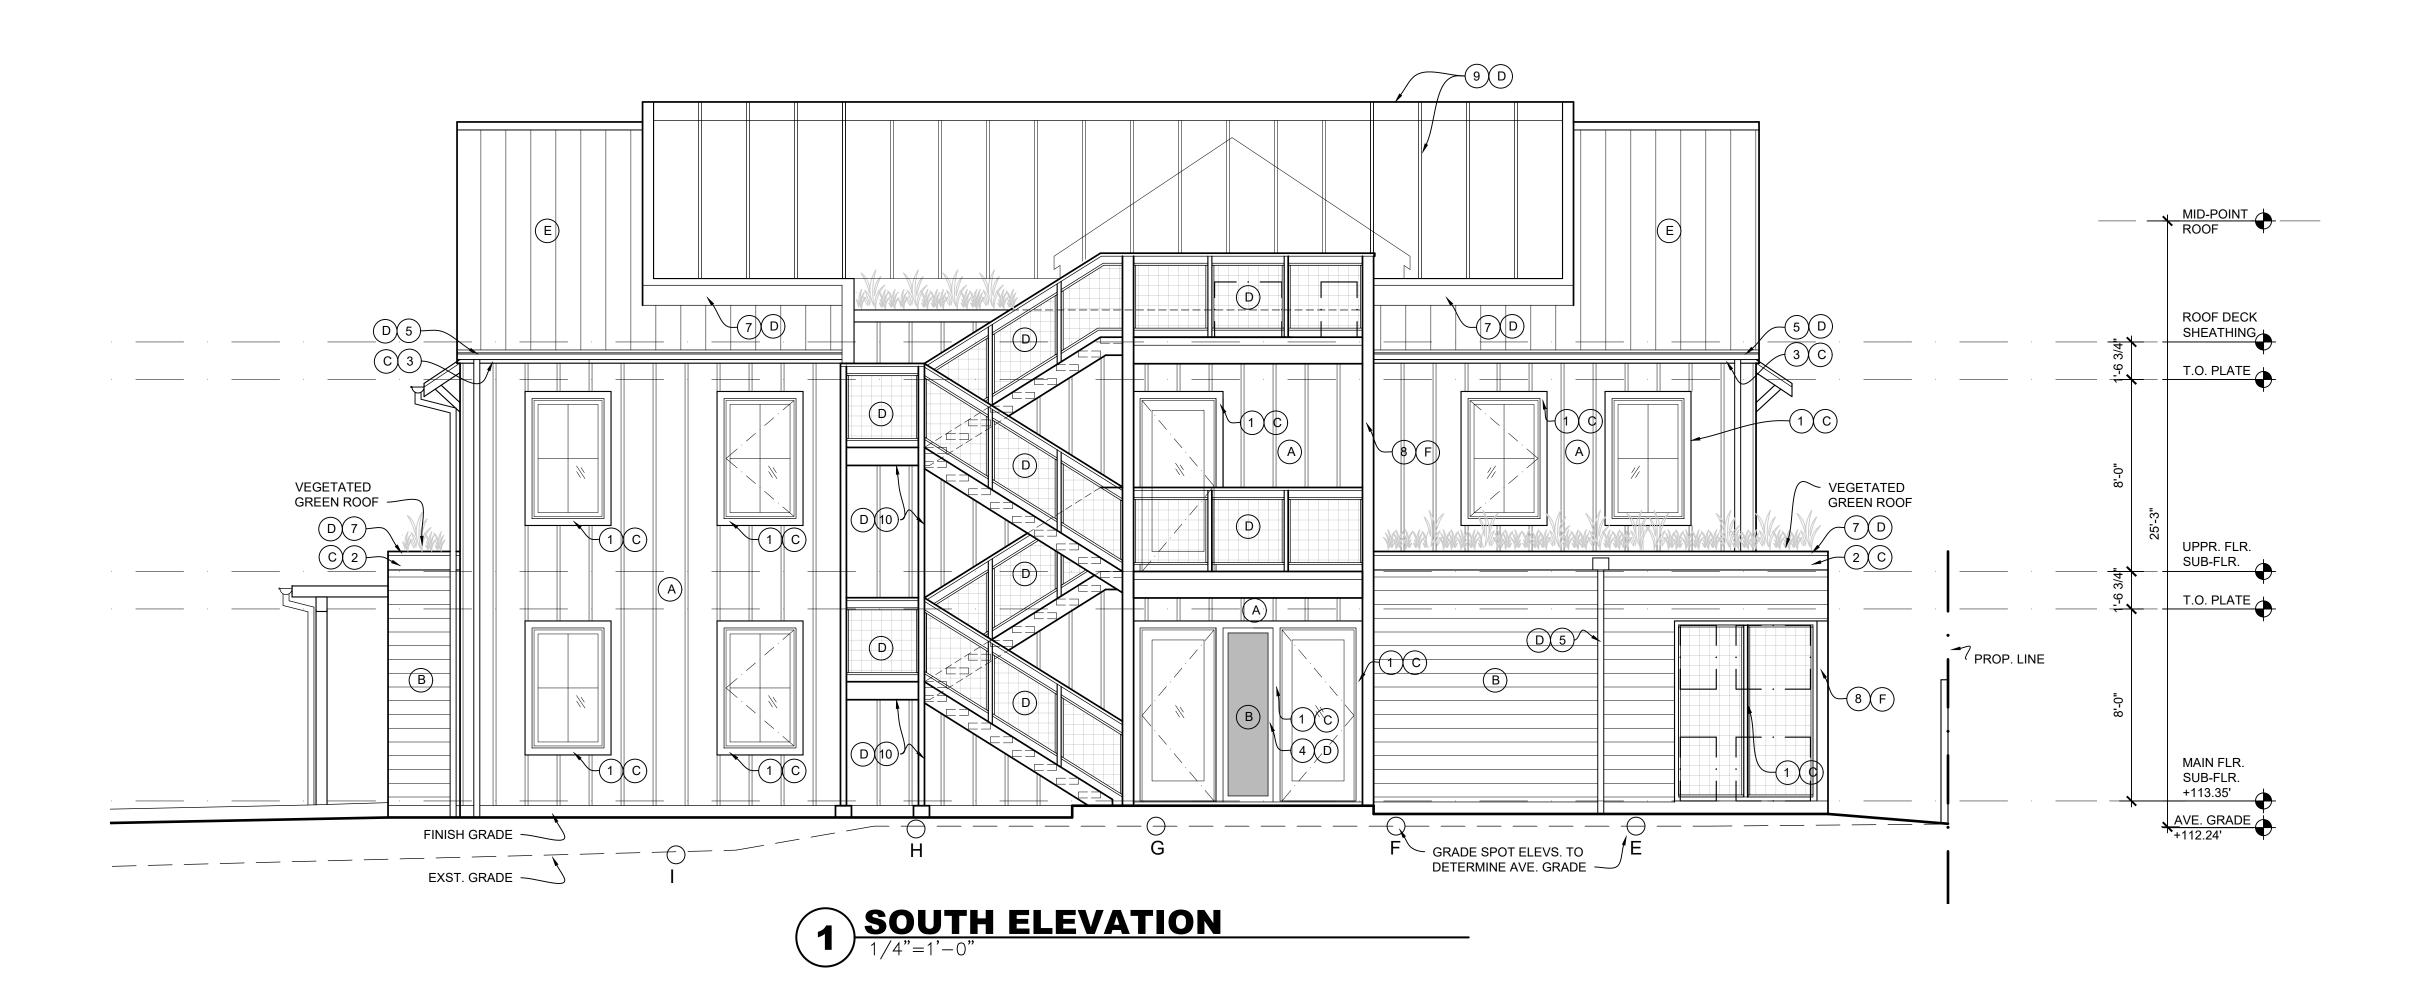



HARDIE WOODGRAIN LAP SIDING 7 1/4" WIDTH, 6" EXPOSURE

HARDI PANEL SMOOTH
VERTICAL SIDING 4' WIDE

BOARD - HARDIE WOODGRAIN PAN

BOARD - HARDIE WOODGRAIN PANEL
VERTICAL SIDING 4' WIDE;
BATTEN - PREPRIMED WHITE SPRUCE
BATTEN BOARDS 3/4" X 1 1/2" @ 16" OC.

METAL STANDING SEAM

WINDOW FRAME & GLAZING

2"X4" METAL WELDED WIRE GRID GUARD (NOT TO ALLOW 4" SPHERE TO PASS THROUGH)

WINDOW & DOOR TRIM - PREPRIMED WHITE SPRUCE 1" X 3 1/2" OR SIM.

GREEN ROOF PARAPET - PREPRIMED WHITE SPRUCE 1" X 9 1/4" OR SIM.

ROOF EDGE TRIM - PREPRIMED WHITE SPRUCE 1" X 5 1/2" OR SIM.

PREPRIMED WHITE SPRUCE 3/4" X

2 1/2" OR SIM.

GUTTERS, COLLECTOR HEADS &

DOWNSPOUTS

6 ATTIC LOUVERED VENT

(7) SHEET METAL COPING

(8) CEDAR WOOD TRELLIS

9 RAFTERS & BEAM TRELLIS, WOOD OR METAL TBD

(10) TUBE STEEL STRUCTURE

LEGEND - COLORS

A VIRTUAL TAUPE, SW 7039

B SMOKEHOUSE, SW 7040

URBANE BRONZE, SW 7048

TRICORN BLACK, SW 6258

EVERGREEN, KINGSPAN 'MORIN'

CLEAR STAIN


L S A

LIVING SHELTER

ARCHITECTS

PLLC

115 15TH AVE. E.
SUITE 100
SEATTLE, WA 98112
(206) 707-8895
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file: 2019262.00
project name:
BRIGHT STARS
FAMILY
DAYCARE

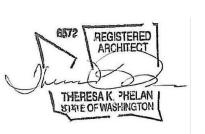owner:
THARAKA & DEEPTHI
DEVADITHYA
project address:

project address: 355 EAST SUNSET WAY ISSAQUAH, WA 98027

> ADMINISTRATIVE SITE DEVELOPMENT PERMIT

city approval stamp:

revisions:

9/29/22 RESPONSE TO CITY COMMENT 12/09/22 RESPONSE TO CITY COMMENT

date: 09 DECEMBER, 2022

sheet title:
SOUTH &
EAST


ELEVATIONS

sheet number:


A2.2



3 NORTHWEST CORNER

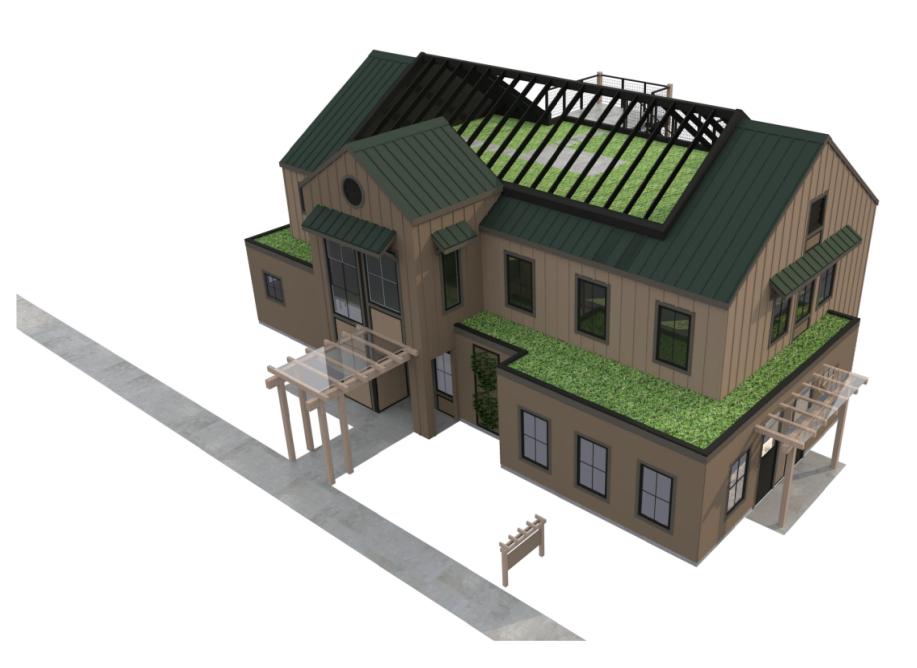


1 BIRD'S EYE - VIEW 1

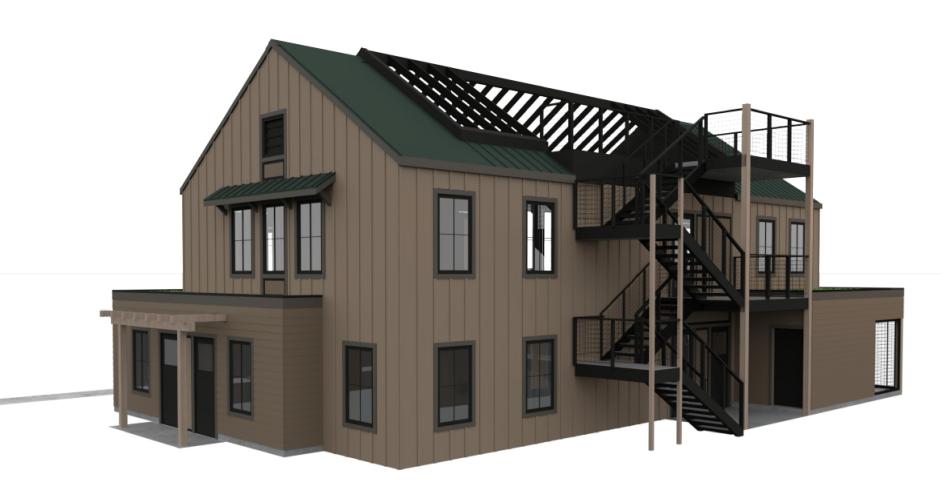

5 SOUTHWEST CORNER



4 NORTHEAST CORNER

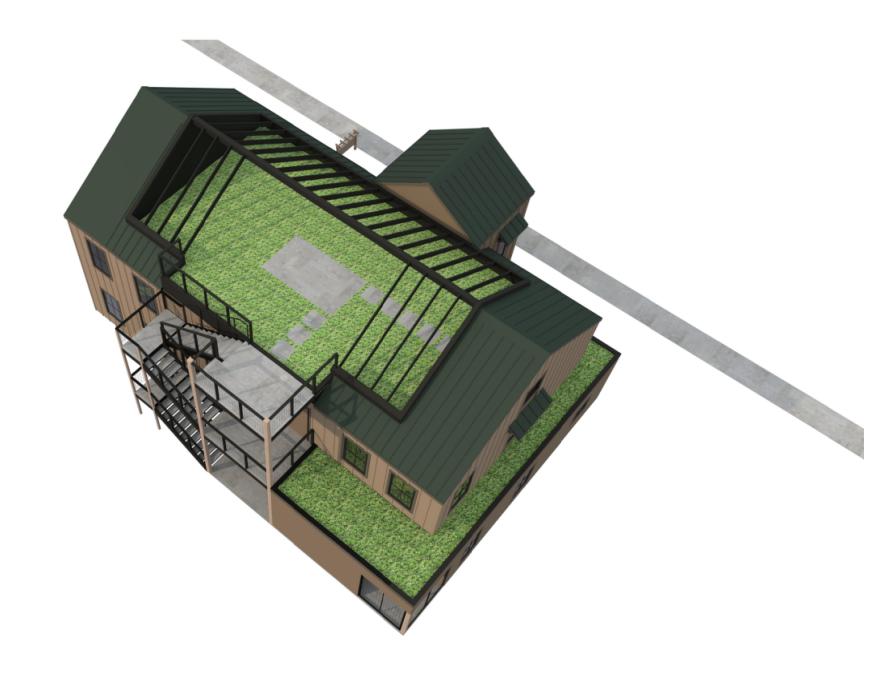


2 BIRD'S EYE - VIEW 2



6 SOUTHEAST CORNER



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revision

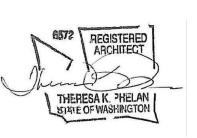9/29/22 RESPONSE
TO CITY COMMENT
12/09/22 RESPONSE
TO CITY COMMENT

e: DECEMBED 20

09 DECEMBER, 2022

COLOR PERSPECTIVES

sheet number:

A2.3

NE 1/4 OF NW 1/4 OF SECTION 34, T. 24 N., R. 06 E., W.M. CITY OF ISSAQUAH, KING COUNTY, STATE OF WASHINGTON

- REPLACED CONCRETE

- PROPOSED CONCRETE

FOUNDATION (TYP)

► PROPERTY

- PROPOSED SPEED

LINE (TYP)

WALKWAY (TYP)

╫┈╩╫╌┰┐

PROPOSED BUILDING * * * *

STAIR CASE

E SUNSET WAY

S87*46'13"F 110.00'

*F * - * - * - * - * - * - * - * - *

- VEGETATED ROOF (TYP)

EX EDGE OF -

EX EDGE OF

PROPOSED -

PROPOSED ASPHALT PARKING

WHEEL STOP

SIDEWALK (TYP)

PROPOSED GRAVEL

WALKWAY (TYP)

PAVEMENT (TYP)

└ PROPOSED TRELLIS

GRASS PLAY AREA

TPN 342406-9096

10'± EX GRAVEL


6'± EX CONCRETE

GATE (TYP) -

PROPOSED 6'

FENCE (TYP)

PUBLIC ALLEY

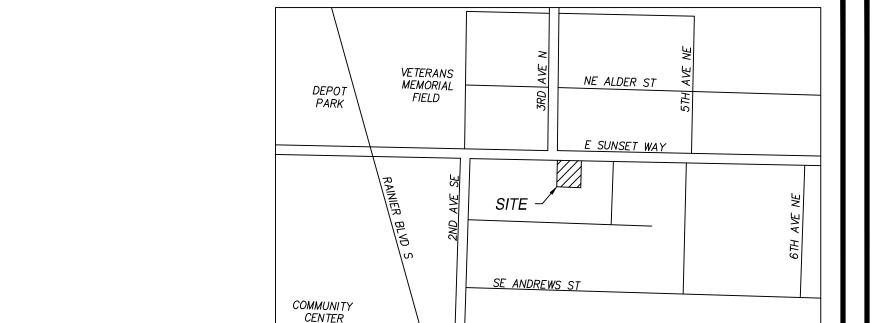

VICINITY MAP N.T.S.

PROJECT TEAM:

APPLICANT:

THARAKA AND DEEPTHI DEVADITHYA 1695 24TH AVE NE

ISSAQUAH, WA 98029 (425) 830-5391

BRIANA BENNINGTON, PE / KEVIN REESE, PLS ENCOMPASS ENGINEERING & SURVEYING ENGINEER/SURVEYOR: 165 N.E. JUNIPER STREET, SUITE 201

ISSAQUAH, WA 98027 (425) 392-0250

ARCHITECT:

LIVING SHELTER ARCHITECTS PLLC 472-A FRONT STREET N ISSAQUAH, WA 98027 (425) 427-8643

SITE DATA:

LOT SIZE:

TAX PARCEL NO: 342406-9096

PROJECT SITE ADDRESS: 355 E SUNSET WAY 98027

MF-H (MULTIFAMILY-HIGH) ZONING:

LEGAL DESCRIPTION:

THAT PORTION OF THE NORTHEAST QUARTER OF THE NORTHWEST QUARTER OF SECTION 34, TOWNSHIP 24 NORTH, RANGE 6 EAST, W.M., IN KING COUNTY, WASHINGTON, DESCRIBED AS FOLLOWS:

13,200 SF (0.30 AC)

BEGINNING AT A POINT ON THE SOUTH LINE OF MILL STREET, WHICH IS 30 FEET SOUTH AND 20 FEET EAST OF THE NORTHWEST CORNER OF SAID

THENCE EAST ALONG SAID SOUTH LINE 110 FEET; THENCE SOUTH 120 FEET;

THENCE NORTH 120 FEET TO THE POINT OF BEGINNING.

SITUATE IN THE COUNTY OF KING, STATE OF WASHINGTON.

TOTAL PROPOSED HARD SURFACE AREAS:

UNCOVERD DRIVEWAY/PARKING (ON-SITE*):

1,077 SF IMPERVIOUS ROOF:

UNCOVERED VEGETATED ROOF: UNCOVERD WALKWAYS/SIDEWALKS/STAIRS (ON-SITE*): 316 SF

TOTAL HARD SURFACE:

13,820 SF

*NOTE: AN ADDITIONAL 180 SF OF STREET WIDENING, 18 SF OF WALKWAY AND 23 SF OF REPLACED SIDEWALK IS PROPOSED OFF-SITE IN THE ROW.

DISTURBANCE AREA:

ON SITE: 13,200SF OFF SITE: 620 SF

BUILDING SETBACKS:

 $/F \setminus FRONT YARD SETBACK:$

SIGHT LIMIT DISTANCE TRIANGLE ASSUMING 15 MPH SPEED LIMIT ON ALLEY (TYP)

 $S \setminus SIDE YARD SETBACK$: /R\ REAR YARD SETBACK:

SHEET INDEX:					
TITLE	SHEE				
COVER SHEET	C1.0				
TESC PLAN	C2.0				
TESC DETAILS	C2.1				
GRADING & DRAINAGE PLAN	C3.0				
UTILITY PLAN	C4.0				
CONSTRUCTION DETAILS I	C5.0				
CONSTRUCTION DETAILS II	C5.1				
CONSTRUCTION DETAILS III	C5.2				

□ Reviewed and determined to be not applicable.

Land Development Manager Date ONLY SHEETS WITH AUTHORIZING SIGNATURES HAVE BEEN APPROVED FOR CONSTRUCTION

EXISTING UTILITY NOTE: ALL LOCATIONS OF EXISTING UTILITIES SHOWN HEREON HAVE BEEN

ESTABLISHED BY FIELD SURVEY OR OBTAINED FROM AVAILABLE RECORDS AND SHOULD THEREFORE BE CONSIDERED APPROXIMATE ONLY AND NOT NECESSARILY COMPLETE. IT IS THE SOLE RESPONSIBILITY OF THE CONTRACTOR TO INDEPENDENTLY VERIFY THE ACCURACY OF ALL UTILITY LOCATIONS SHOWN AND TO FURTHER DISCOVER AND AVOID ANY OTHER UTILITIES NOT SHOWN HEREON WHICH MAY BE AFFECTED BY THE IMPLEMENTATION OF THIS PLAN.

CONTRACTOR RESPONSIBILITY:

CONTRACTOR AGREES THAT HE SHALL ASSUME SOLE AND COMPLETE RESPONSIBILITY FOR JOB SITE CONDITIONS, INCLUDING THE SAFETY OF ALL PERSONS AND PROPERTY, DURING THE COURSE OF CONSTRUCTION OF THIS PROJECT, AND THAT THIS REQUIREMENT SHALL APPLY CONTINUOUSLY AND NOT BE LIMITED TO NORMAL WORKING HOURS. THE CONTRACTOR SHALL DEFEND, INDEMNIFY AND HOLD THE OWNER AND THE ENGINEER HARMLESS FROM ANY AND ALL LIABILITY, REAL OR ALLEGED, IN CONNECTION WITH THE PERFORMANCE OF WORK ON THIS PROJECT, EXCEPTING FOR LIABILITY ARISING FROM THE SOLE NEGLIGENCE OF THE OWNER OR THE ENGINEER.

DISCREPANCIES:

IF THERE ARE ANY DISCREPANCIES BETWEEN DIMENSIONS IN DRAWINGS AND EXISTING CONDITIONS WHICH WILL AFFECT THE WORK, THE CONTRACTOR SHALL BRING SUCH DISCREPANCIES TO THE ATTENTION OF THE ENGINEER FOR ADJUSTMENT BEFORE PROCEEDING WITH THE WORK. THE CONTRACTOR SHALL BE RESPONSIBLE FOR THE PROPER FITTING OF ALL WORK AND FOR THE COORDINATION OF ALL TRADES, SUBCONTRACTORS, AND PERSONS ENGAGED UPON THIS

CONTRACTOR NOTES:

1. THE CONTRACTOR SHALL HAVE APPROVED PLANS, STANDARD NOTES, STANDARD DETAILS AND SPECIFICATIONS AVAILABLE ON

CONTRACTOR TO COORDINATE CONNECTIONS TO DRY UTILITIES. CALL 811 FOR UTILITY LOCATES.

Know what's **below.** Call before you dig.

Date CPD Engineer □Reviewed and determined □Reviewed and determined to be not applicable. to be not applicable.

APPROVAL CONDITIONS

SCALE 1"=10' DESIGNED PMS DRAWN CHECKED APPROVED


SHEET

21695 09/29/202

09/29/2022

NE 1/4 OF NW 1/4 OF SECTION 34, T. 24 N., R. 06 E., W.M. CITY OF ISSAQUAH, KING COUNTY, STATE OF WASHINGTON

E SUNSET WAY

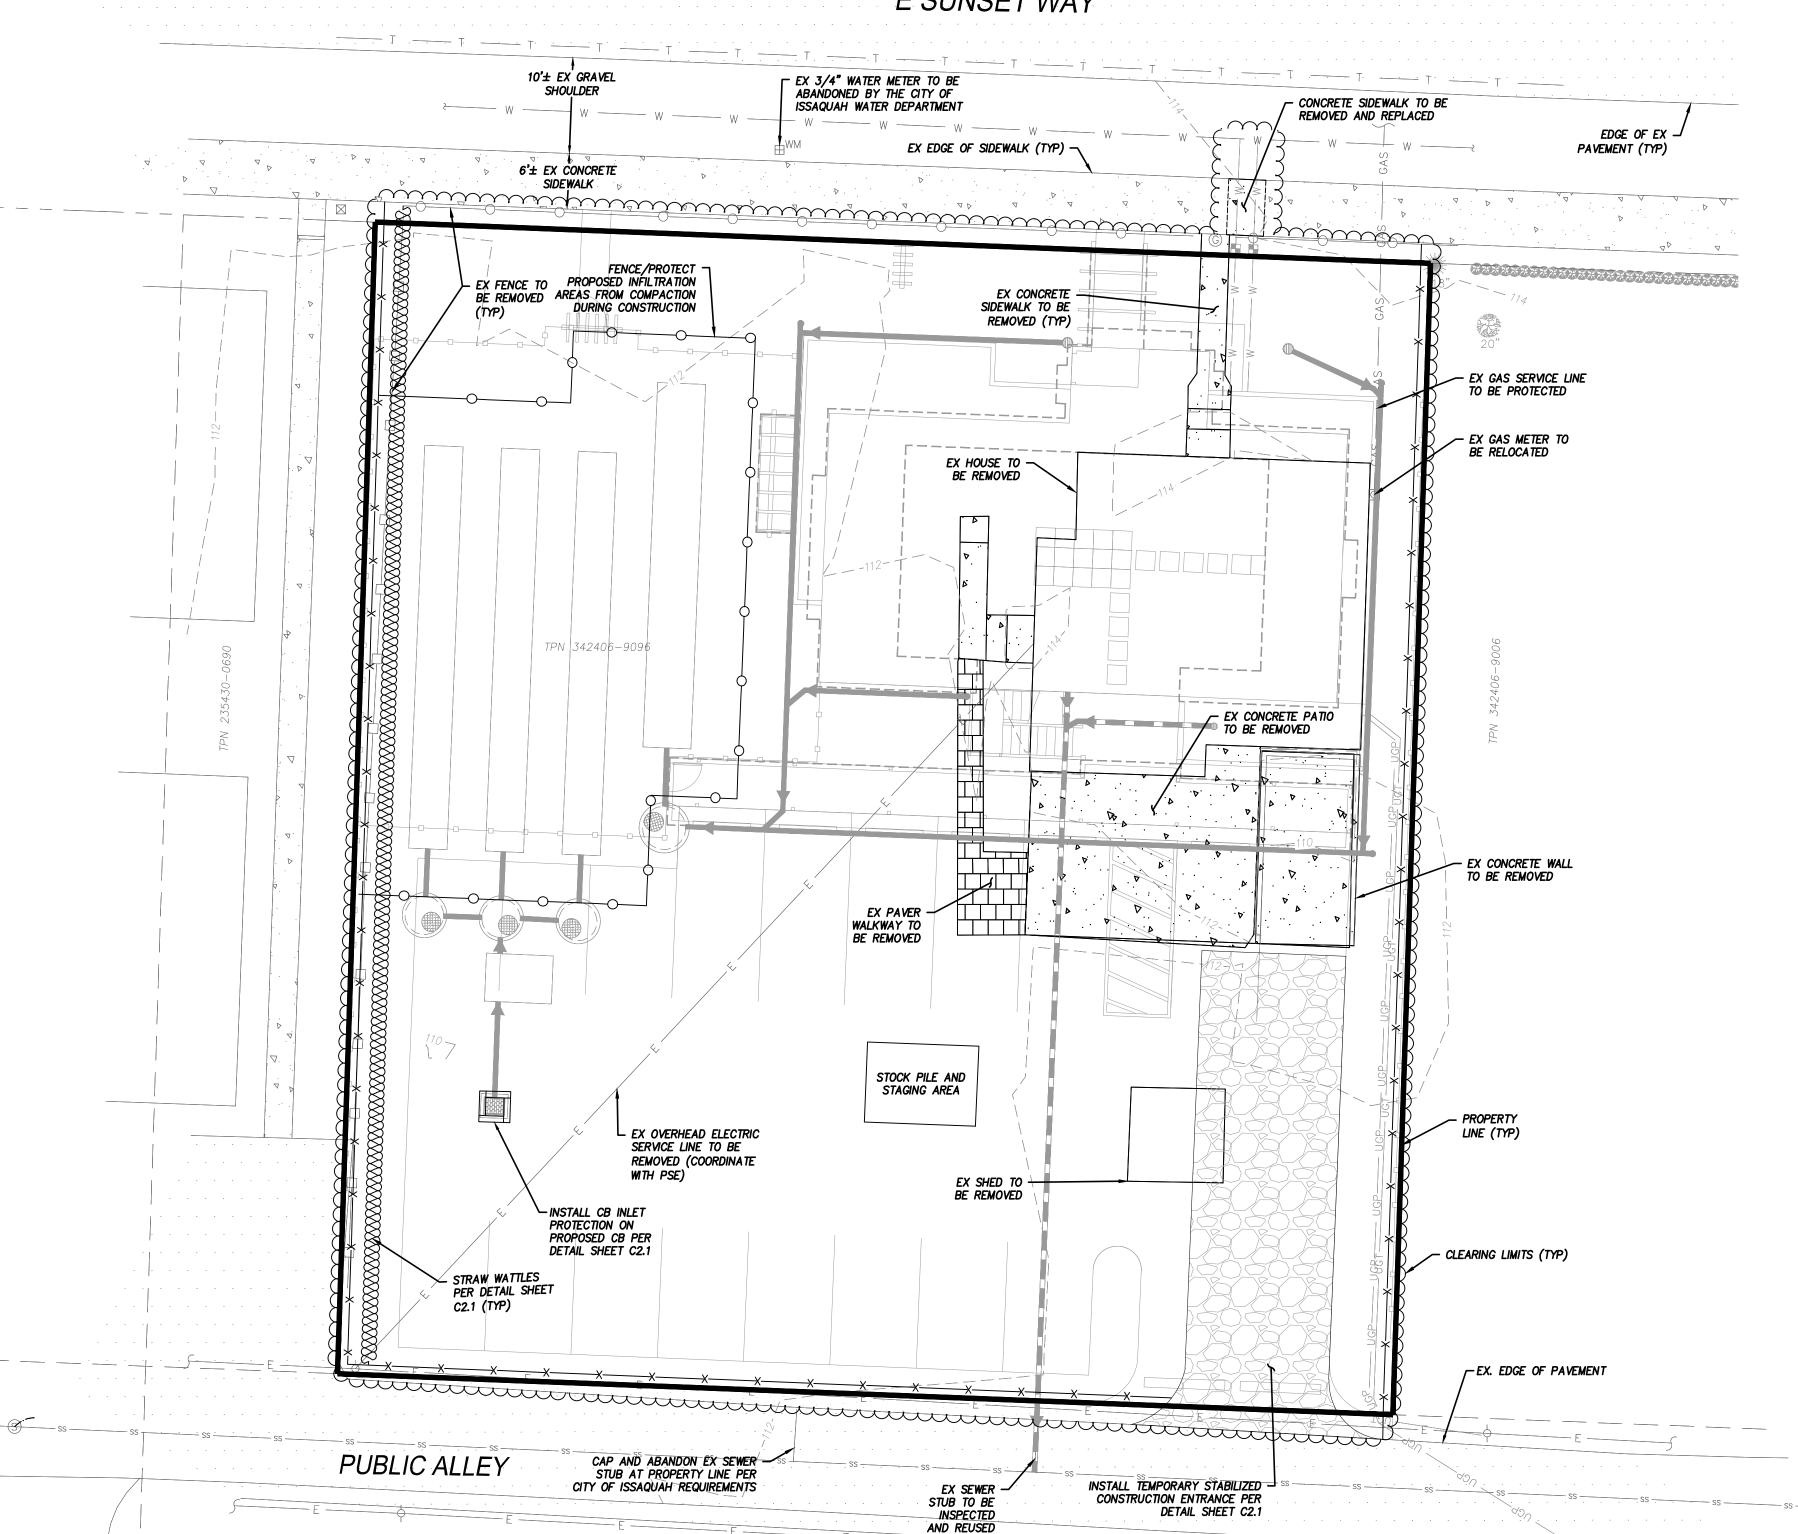

RECOMMENDED CONSTRUCTION SEQUENCE:

- 1. PRE-CONSTRUCTION MEETING.
- 2. FLAG OR FENCE CLEARING LIMITS.
- 3. POST NOTICE OF CONSTRUCTION ACTIVITY SIGN WITH NAME AND PHONE NUMBER OF
- 4. INSTALL CATCH BASIN PROTECTION AS NEEDED FOR ALL EXISTING CBS IN E SUNSET
- WAY AND THE PUBLIC ALLEY WITHIN 100 FEET OF THE SITE. INSTALL CB PROTECTION ON ALL PROPOSED CB'S ONSITE. SEE SHEET C3.0 FOR LOCATION OF PROPOSED CB'S.
- 5. GRADE AND INSTALL CONSTRUCTION ENTRANCE(S).
- 6. INSTALL PERIMETER PROTECTION (SILT FENCE, STRAW WATTLES, ETC.).
- 7. CONSTRUCT SURFACE WATER CONTROLS (INTERCEPTOR DIKES, PIPE SLOPE DRAINS, ETC.) SIMULTANEOUSLY WITH CLEARING AND GRADING FOR PROJECT DEVELOPMENT.
- 8. MAINTAIN EROSION CONTROL MEASURES IN ACCORDANCE WITH CITY OF ISSAQUAH STANDARDS AND MANUFACTURER'S RECOMMENDATIONS.
- 9. RELOCATE SURFACE WATER CONTROLS AND EROSION CONTROL MEASURES OR INSTALL NEW MEASURES SO THAT AS SITE CONDITIONS CHANGE THE EROSION AND SEDIMENT CONTROL IS ALWAYS IN ACCORDANCE WITH CITY OF ISSAQUAH EROSION AND SEDIMENT CONTROL STANDARDS.
- 10.COVER ALL AREAS THAT WILL BE UNWORKED FOR MORE THAN SEVEN DAYS DURING THE DRY SEASON OR TWO DAYS DURING THE WET SEASON WITH STRAW, WOOD FIBER MULCH, COMPOST, PLASTIC SHEETING OR EQUIVALENT.
- 11. STABILIZE ALL AREAS THAT REACH FINAL GRADE WITHIN SEVEN DAYS.
- 12. SEED OR SOD ANY AREAS TO REMAIN UNWORKED FOR MORE THAN 30 DAYS. 13.UPON COMPLETION OF THE PROJECT, ALL DISTURBED AREAS MUST BE STABILIZED AND BMPS REMOVED IF APPROPRIATE.

SITE ACCESS NOTE:
ALLEY LOCATED ALONG SOUTH PROPERTY LINE SHALL BE SOLE ACCESS ROAD FOR BRIGHT STARS DAYCARE CONSTRUCTION HAUL AND WORKER TRAFFIC TO ACCESS THE SITE, UNLESS THE APPLICANT CAN SHOW USE OF THIS ROAD IS NOT PHYSICALLY FEASIBLE OR IS HAZARDOUS DUE TO WEATHER AND/OR ROAD CONDITIONS FOR EQUIPMENT AND THE CITY APPROVES AN ALTERNATE ROUTE. CONTRACTORS WILL BE REQUIRED TO GIVE NOTICE TO CITY DURING PERMIT APPLICATION AND REVIEW PROCESS SHOULD THE USE OF E. SUNSET WAY FOR SITE ACCESS BE DEEMED NECESSARY AND APPROPRIATE DURING CONSTRUCTION; HOWEVER, ADDITIONAL CONTRACTOR REQUEST AND CITY REVIEW MAY OCCUR DURING CONSTRUCTION.

ASBESTOS TESTING NOTE ASBESTOS SURVEY AND REMEDIATION REPORT TO BE COMPLETED BY AN AHERA CERTIFIED BUILDING INSPECTOR PRIOR TO COMPLETING DEMOLITION WORK.

Know what's **below**.

Call before you dig.

APPROVAL CONDITIONS

Date CPD Engineer

□ Reviewed and determined □ Reviewed and determined to be not applicable.

☐ Reviewed and determined to be not applicable.

Land Development Manager Date ONLY SHEETS WITH AUTHORIZING SIGNATURES HAVE BEEN APPROVED FOR CONSTRUCTION

to be not applicable.

SCALE 1"=10' DESIGNED DRAWN CHECKED APPROVED SHEET

09/29/2022

SURVEY LEGEND:

EX. WATER METER

EX. SEWER MANHOLE

EX. 6' WIDE 4' HIGH HEDGE

EX. HOLLY TREE TO REMAIN

EX. PINE TREE TO REMAIN

EX. OVERHEAD POWER LINE

EX. POWER BOX


EX. GATE


— ⊤ — ⊤ — EX. FIBER OPTIC LOCATE


——— W ———— EX. 8" DI WATER MAIN


EX. GAS METER EX. UTILITY POLE

NE 1/4 OF NW 1/4 OF SECTION 34, T. 24 N., R. 06 E., W.M. CITY OF ISSAQUAH, KING COUNTY, STATE OF WASHINGTON

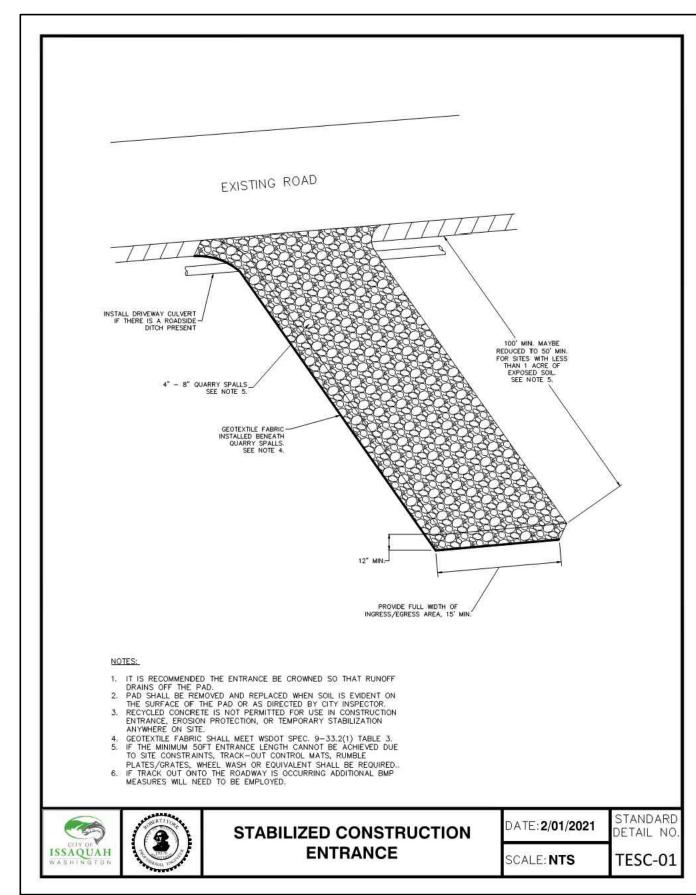

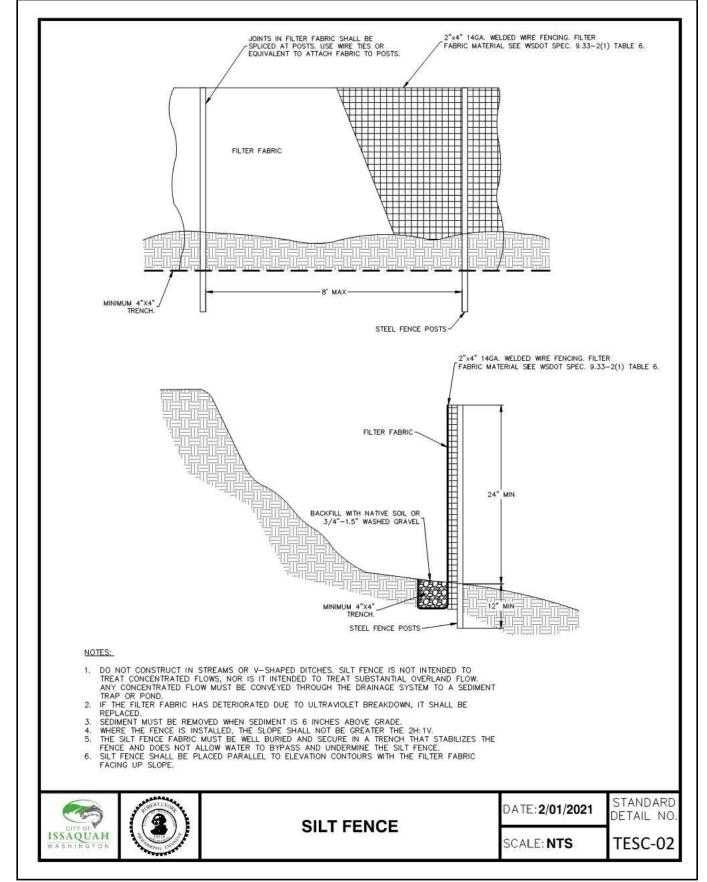

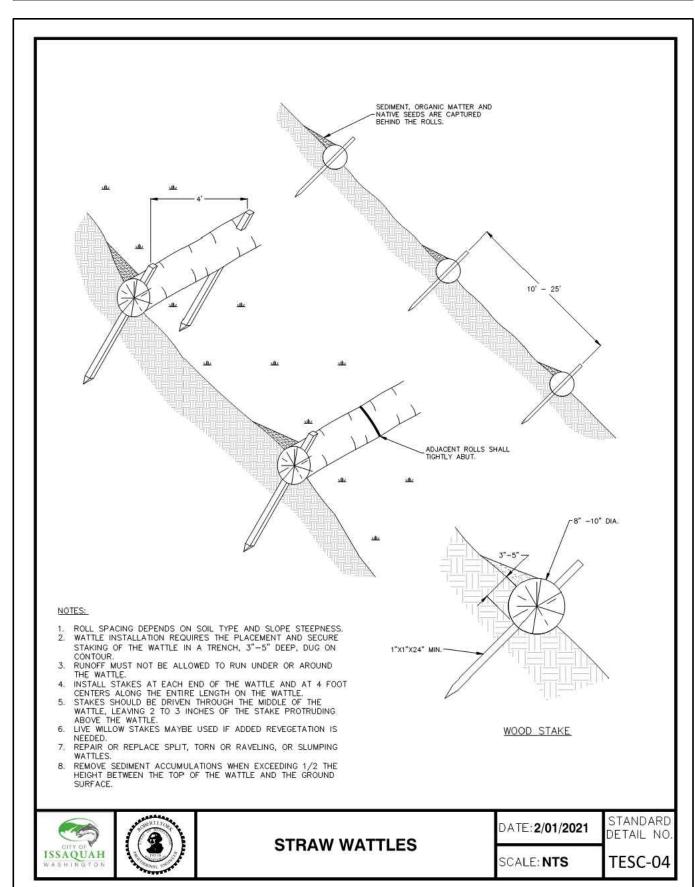

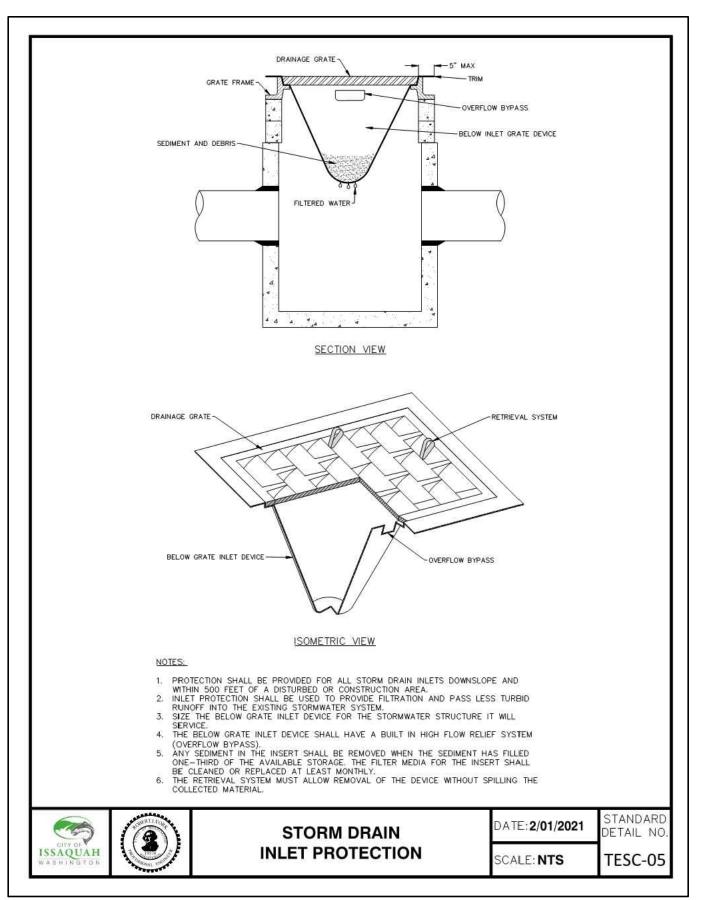




CPD Planner Date	CPD Engineer Dat
□Reviewed and determined to be not applicable.	
CPD Planner Date	
☐ Reviewed and determined to be not applicable.	CITY OF ISSAOUAH

ONLY SHEETS WITH AUTHORIZING SIGNATURES HAVE BEEN APPROVED FOR CONSTRUCTION

APPROVAL CONDITIONS

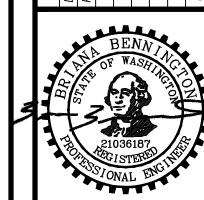

DAYCAR DEEPTHI DE DETAIL STARS

09/29/2022

BRIGHT

NTS

09/29/2022 SCALE BLB DESIGNED PMS DRAWN CHECKED APPROVED

SHEET

SURVEY LEGEND:

EX. WATER METER

EX. GAS METER

EX. UTILITY POLE

EX. POWER BOX

EX. GATE

— T — T — EX. FIBER OPTIC LOCATE

EX. 8" SEWER LINE

——— W ——— EX. 8" DI WATER MAIN

EX. SEWER MANHOLE

EX. 6' WIDE 4' HIGH HEDGE

EX. HOLLY TREE TO REMAIN


EX. PINE TREE TO REMAIN

---- EX. OVERHEAD POWER LINE

BRIGHT STARS FAMILY DAYCARE

NE 1/4 OF NW 1/4 OF SECTION 34, T. 24 N., R. 06 E., W.M. CITY OF ISSAQUAH, KING COUNTY, STATE OF WASHINGTON

E SUNSET WAY

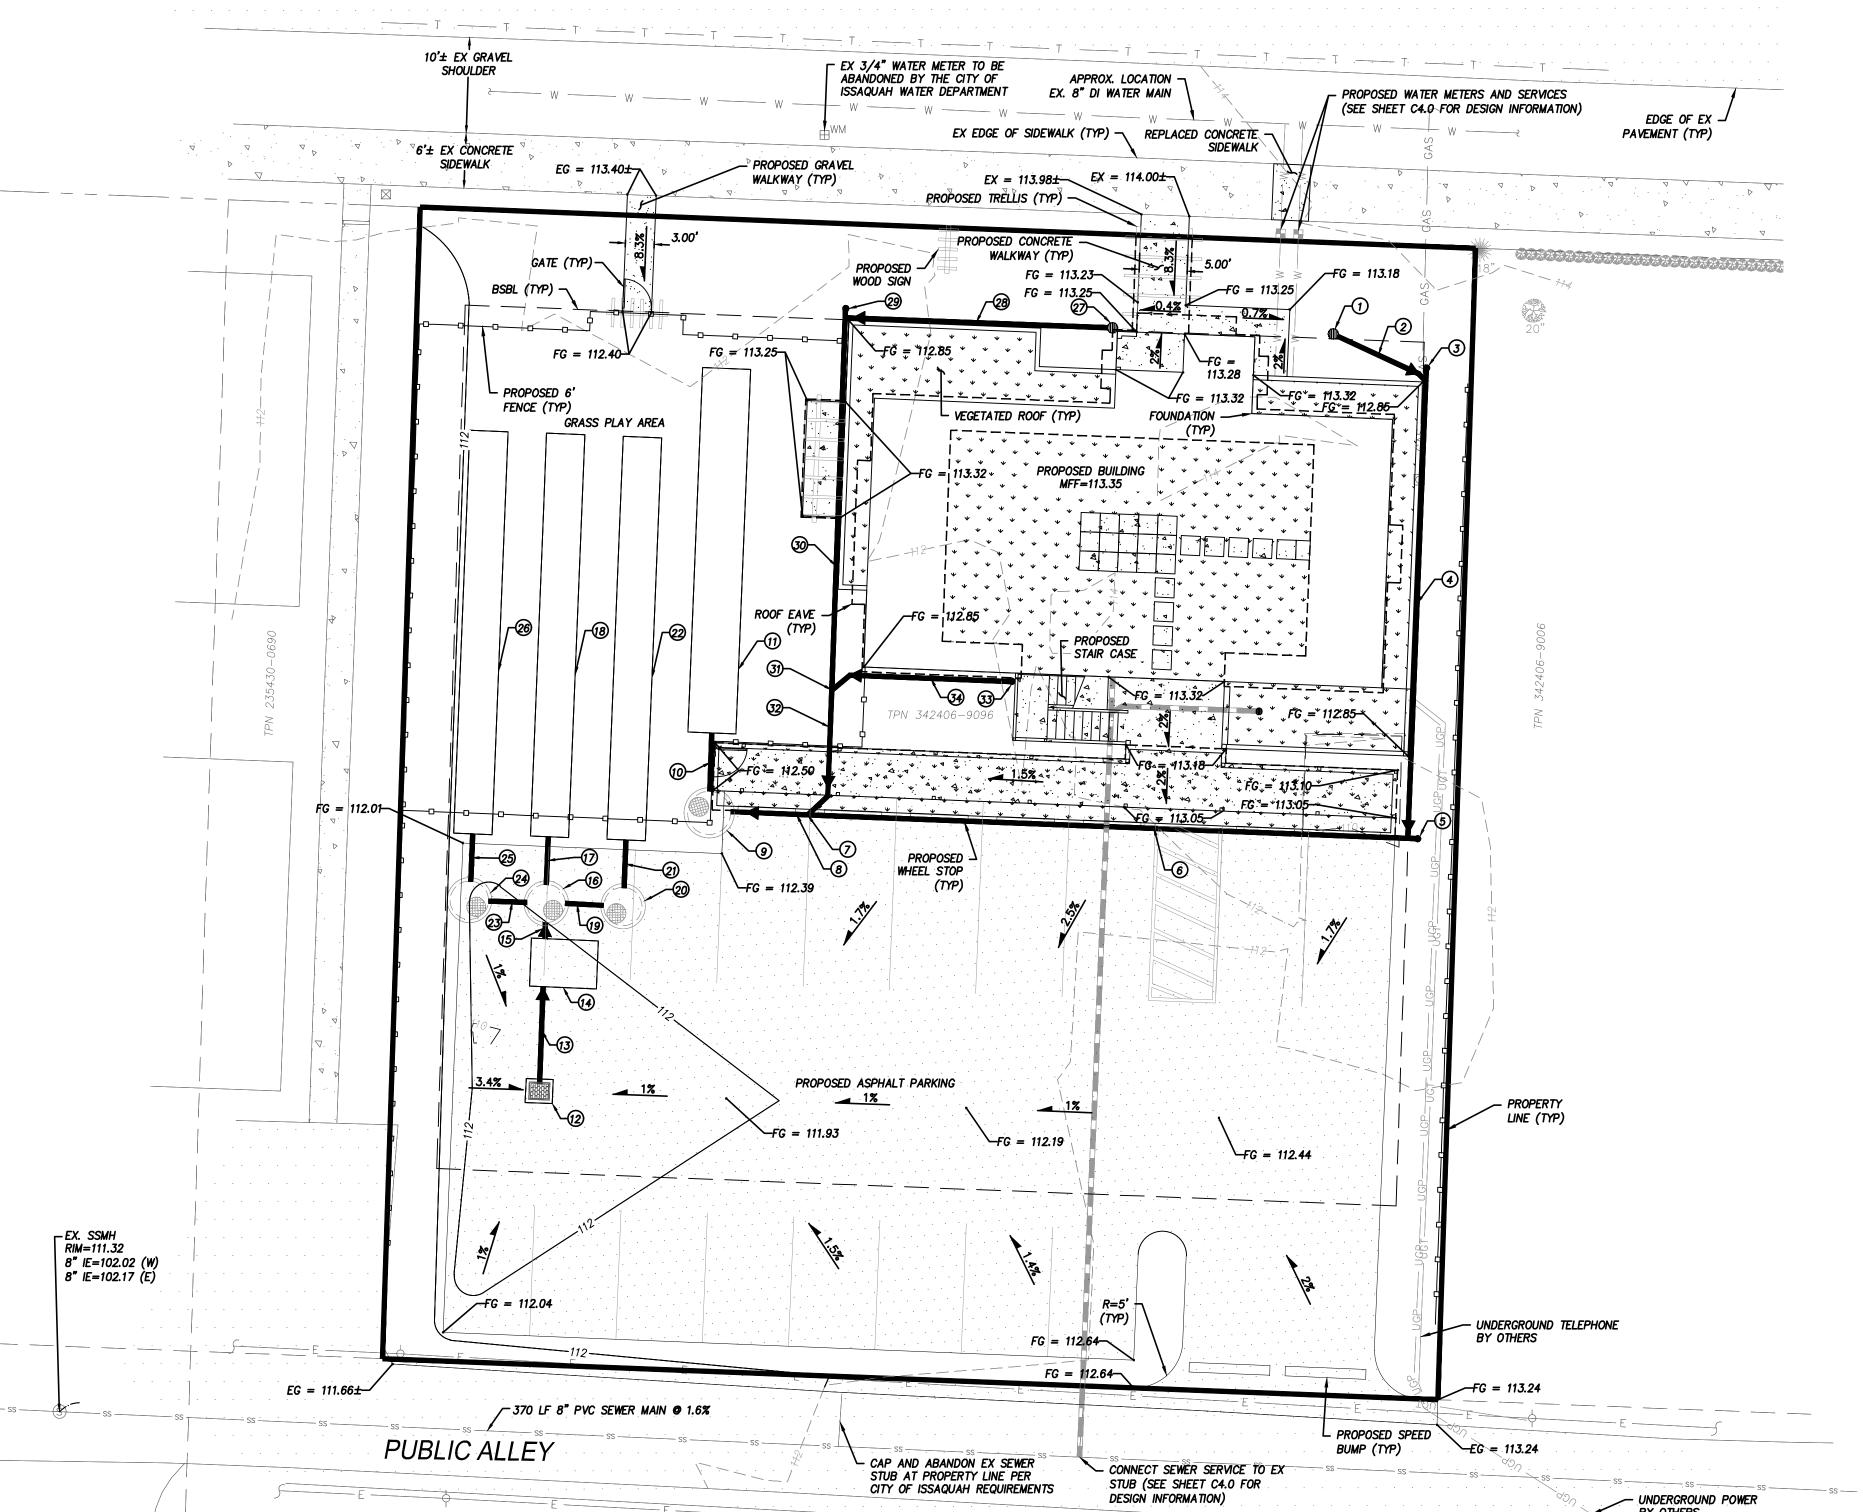

STORM KEYNOTES:

1) AREA DRAIN RIM = 113.13 6" IE (SE) = 112.13

2)11 LF 6" PVC @ 1%

③ SDCO RIM 6" IE (NW,S) = 112.02

4 48 LF 6" PVC @ 1% ⑤ SDCO RIM 6" IE (N,W) = 111.54

6) 61 LF 6" PVC @ 1% 76" WYE IE = 110.93

8 11 LF 6" PVC 0 1% 9 TYPE 2 - 54" CB W/ SOLID LID RIM = 112.50 6" IE (E) = 110.82 36" IE (N) = 107.25

(10) 7 LF 36" PVC (LEVEL) 1) 5'x38' ROOF DOWNSPOUT INFILTRATION TRENCH

PER DETAIL SHEET C5.2 (SEE NOTE 3) $FG = 112.50 \pm$ ROCK RIM = 110.7536" IE = 107.25 ROCK BOT = 104.50

② TYPE 1 CB W/ GRATE RIM = 111.75 6" IE (N) = 109.61 (13)11 LF 6" PVC @ 1%

(14) MWS-L-4-4 MODULAR
WETLAND PER DETAIL
SHEET C5.2
RIM = 112.00±
6" IE (S) = 109.50
6" IE (N) = 108.00

SOLID LID 6" IE (S) = 107.98

> (18) 4'x42' PARKING LOT INFILTRATION TRENCH PER DETAIL SHEET C5.2 FG = 112.15± ROCK RIM = 108.00 24" IE = 105.50

24" IE (N,W,E)= 105.50

ROCK BOT = 104.506" IE (W) = 111.26 34 19 LF 6" PVC @ 1% ② TYPE 2 - 48" CB W/ SOLID LID RIM = 112.20 24" IE (N,W) = 105.50

2) 5 LF 24" PVC (LEVEL) 22) 4'x42' PARKING LOT INFILTRATION TRENCH PER DETAIL SHEET C5.2 FG = 112.35± ROCK RIM = 108.00

6" IE (W) = 111.74

6" IE (E,S) = 111.47

30 40 LF 6" PVC @ 1%

306" WYE IE = 111.07

32)14 LF 6" PVC @ 1%

28) 27 LF 6" PVC @ 1%

26) 4'x42' PARKING LOT DETAIL SHEET C5.2 FG = 112.00± ROCK RIM = 108.00 24" IE = 105.50 ROCK BOT = 104.50

23) 5 LF 24" PVC (LEVEL)

② TYPE 2 - 48" CB W/ SOLID LID RIM = 112.00

25 5 LF 24" PVC (LEVEL)

24" IE (N,E) = 105.50

CONSTRUCTION NOTES:

- 1. HMA PAVEMENT REPLACEMENT SHALL BE OF THE SAME COMPOSITION AND THICKNESS AS THE EXISTING PAVEMENT IT ABUTS. ALL HMA ASPHALT SHALL BE COMPACTED TO 95% MAX. DENSITY. ALL SUBGRADE AND BASE FOR THE INSTALLATION SHALL BE COMPACTED TO 95% MODIFIED PROCTOR.
- 2. ALL REPLACEMENT SIDEWALK SHALL BE OF THE SAME TYPE AND THICKNESS AS THE EXISTING SIDEWALK WHICH IT ABUTS. ALL SUBGRADE AND BASE FOR THE INSTALLATION SHALL BE COMPACTED TO 95% MODIFIED
- 3. CONNECT ALL ROOF DOWNSPOUT DRAINS (VEGETATED AND IMPERVIOUS ROOFTOPS) TO 6" PVC TIGHTLINE FOR CONVEYANCE OF DRAINAGE INTO ROOF DOWNSPOUT INFILTRATION BED SYSTEM. DO NOT CONNECT FOOTING, DRAINS TO INFILTRATION SYSTEM. CONNECT FOOTING DRAINS (IF PROVIDED) TO SEPARATE 4' DIAMETER DRYWELL PER DETAIL SHEET C5.0.

APPROVAL CONDITIONS

Date CPD Engineer

□Reviewed and determined □Reviewed and determined to be not applicable. to be not applicable.

CPD Planner □ Reviewed and determined to be not applicable.

Know what's **below.** Call before you dig.

Land Development Manager Date ONLY SHEETS WITH AUTHORIZING SIGNATURES HAVE BEEN APPROVED FOR CONSTRUCTION

09/29/2022

PLAN DAYC, BRIGHT

21695 09/29/202 SCALE 1"=10' DESIGNED PMS DRAWN CHECKED APPROVED

SHEET

SURVEY LEGEND:

EX. WATER METER EX. GAS METER

EX. UTILITY POLE

EX. POWER BOX

EX. HOLLY TREE

EX. PINE TREE

----- EX. OVERHEAD POWER LINE

— T — T — EX. FIBER OPTIC LOCATE

——— W ———— EX. 8" DI WATER MAIN


EX. GATE

EX. SEWER MANHOLE

EX. 6' WIDE 4' HIGH HEDGE

BRIGHT STARS FAMILY DAYCARE

NE 1/4 OF NW 1/4 OF SECTION 34, T. 24 N., R. 06 E., W.M. CITY OF ISSAQUAH, KING COUNTY, STATE OF WASHINGTON

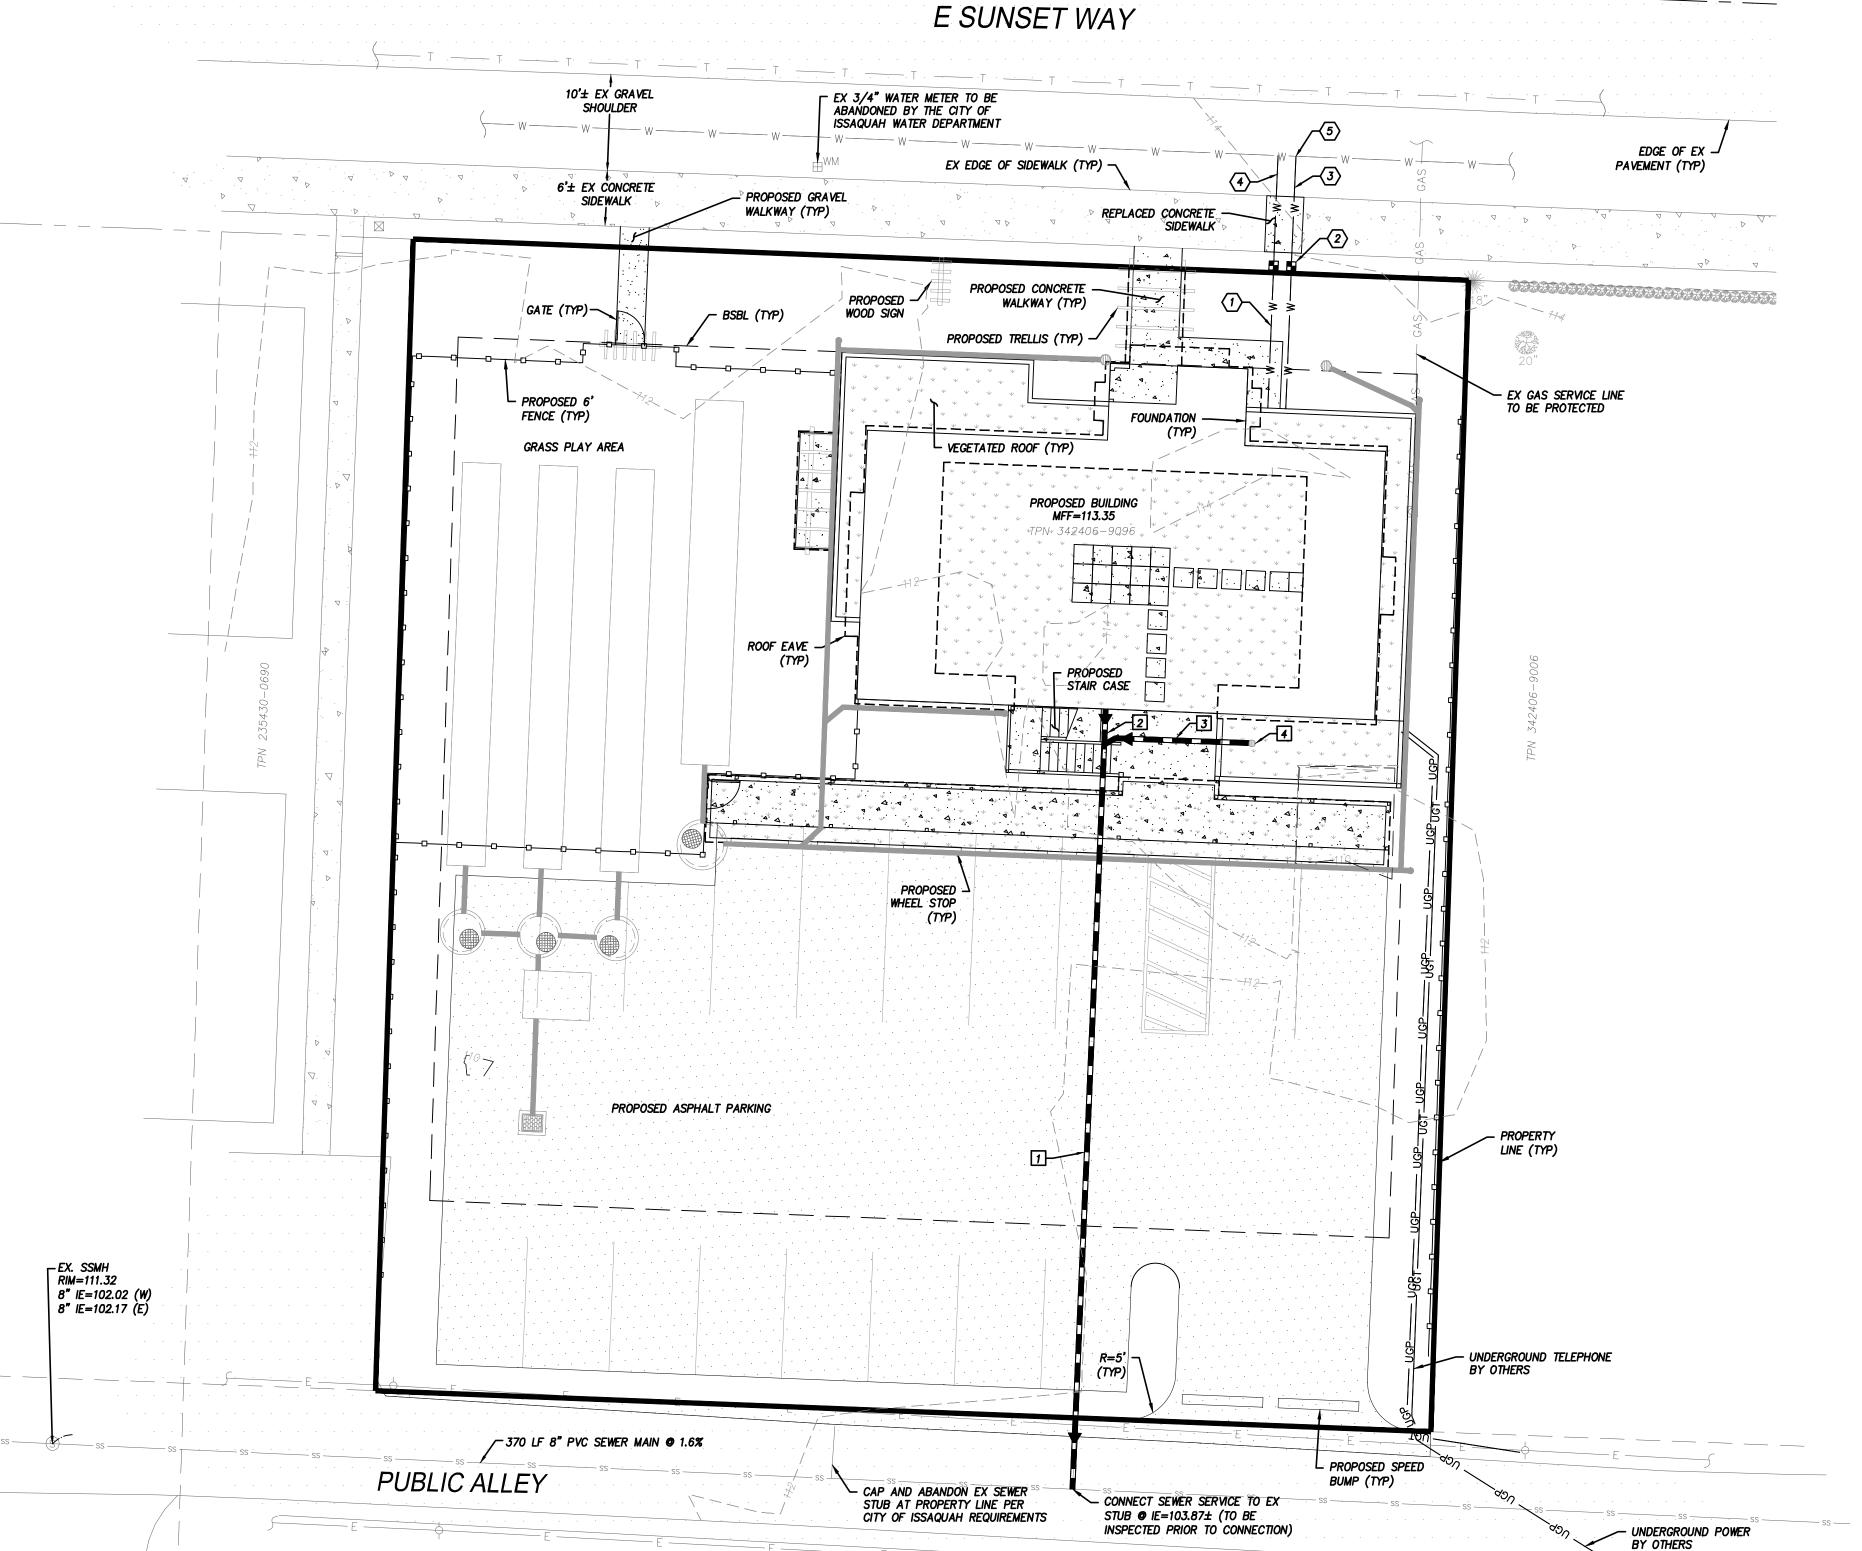

WATER KEYNOTES:

- 1 1/4" WATER SERVICE TO BUILDING (TYP)
- 2 1" WATER METER TO BE INSTALLED BY CITY OF ISSAQUAH PERSONNEL UNLESS OTHERWISE APPROVED (TYP)
- 3 1" WATER SERVICE TO BE INSTALLED BY CITY OF ISSAQUAH PERSONNEL UNLESS OTHERWISE APPROVED
- 4 1" FIRE PROTECTION SERVICE TO BE INSTALLED BY CITY OF ISSAQUAH PERSONNEL UNLESS OTHERWISE APPROVED
- 5 CONNECTION OF WATER SERVICES TO CITY MAIN TO BE INSTALLED BY CITY OF ISSAQUAH PERSONNEL UNLESS OTHERWISE APPROVED (TYP)

SEWER KEYNOTES:

- 1 81 LF 6" PVC SIDE SEWER @ MIN 2%
- 2 INSTALL SSCO WITHIN 3' OF BUILDING
- 3 15 LF 6" PVC SIDE SEWER @ MIN 2%
- 4 INSTALL AREA DRAIN AND CONNECTION TO SEWER FOR TRASH/RECYCLE ENCLOSURE

A SEPARATE (PLM) PLUMBING PERMIT IS REQUIRED FOR THE INSTALLATION OF BACKFLOW ASSEMBLIES.

APPROVAL CONDITIONS

Date CPD Engineer

 \square Reviewed and determined \square Reviewed and determined to be not applicable. to be not applicable.

□Reviewed and determined to be not applicable.

Land Development Manager Date

Know what's **below**.

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09/29/2022


21695 09/29/202 1"=10' DESIGNED DRAWN CHECKED


SCALE


APPROVED


SHEET


NE 1/4 OF NW 1/4 OF SECTION 34, T. 24 N., R. 06 E., W.M. CITY OF ISSAQUAH, KING COUNTY, STATE OF WASHINGTON

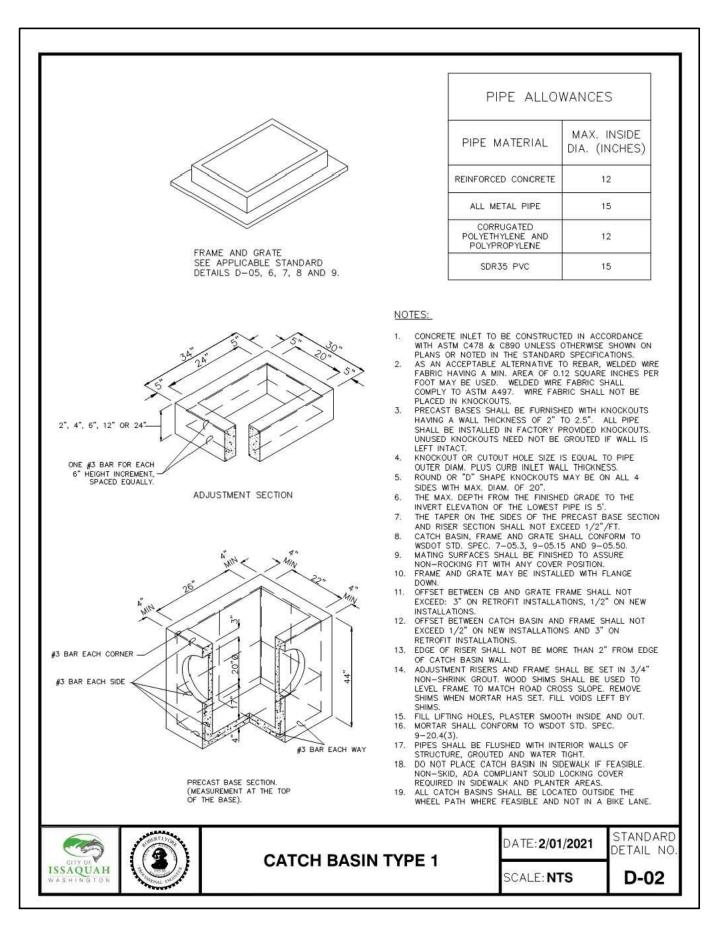


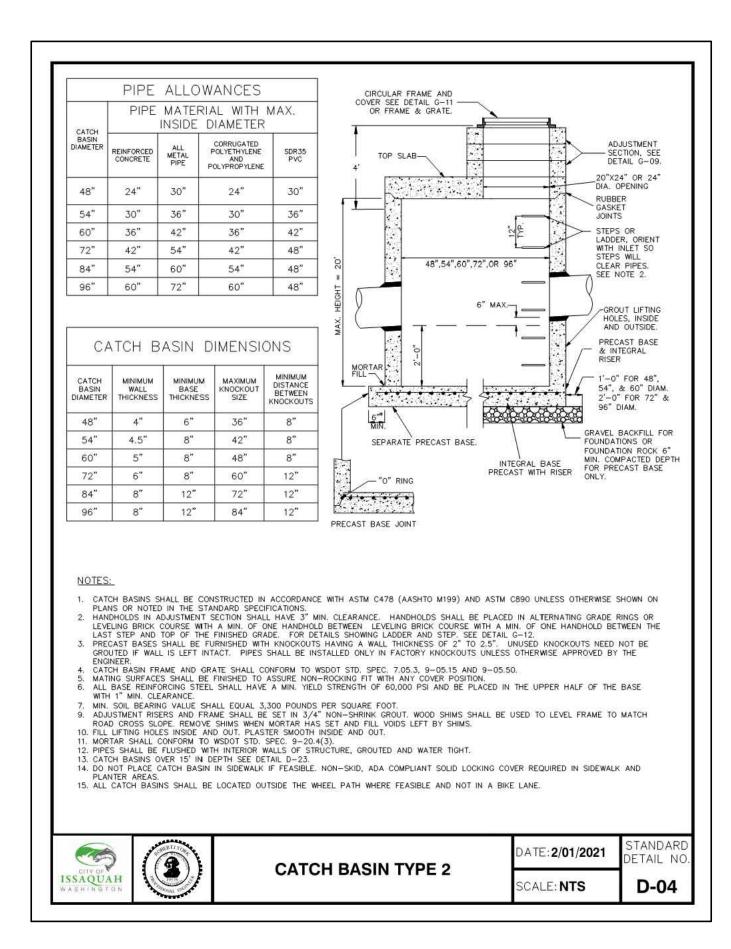


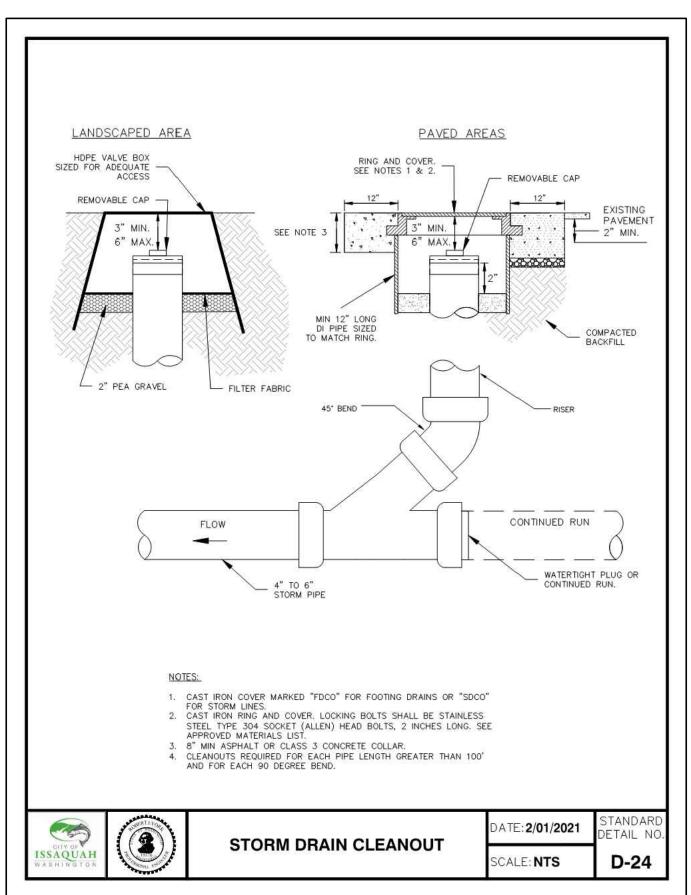


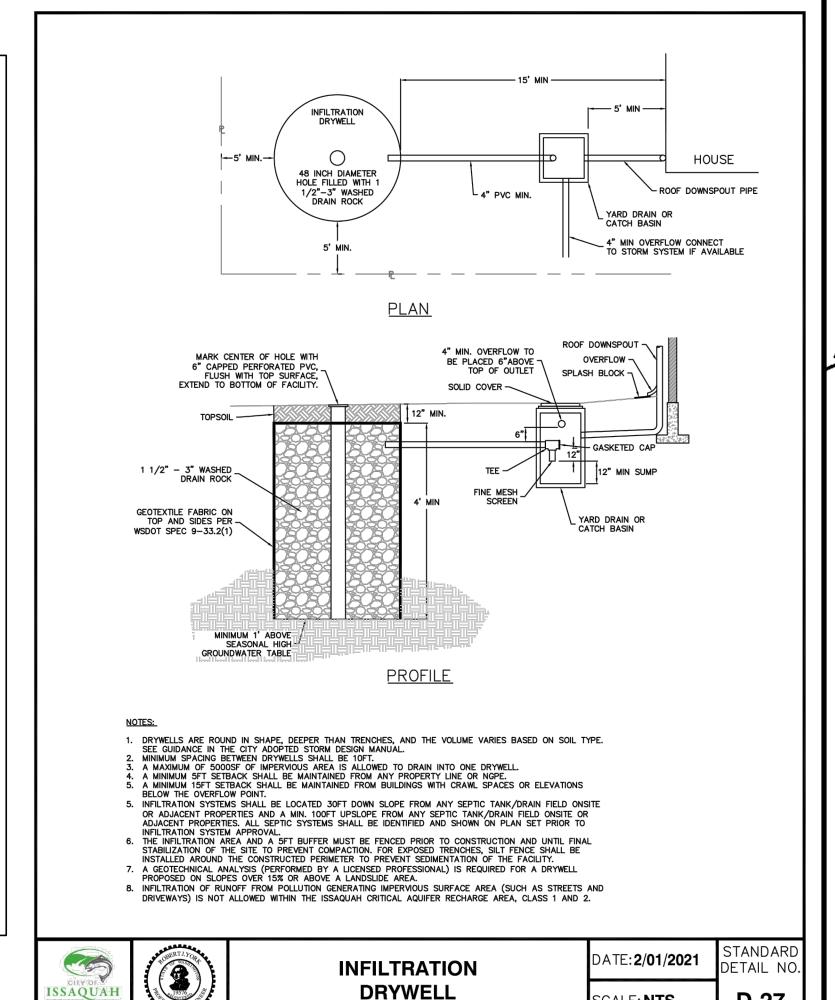

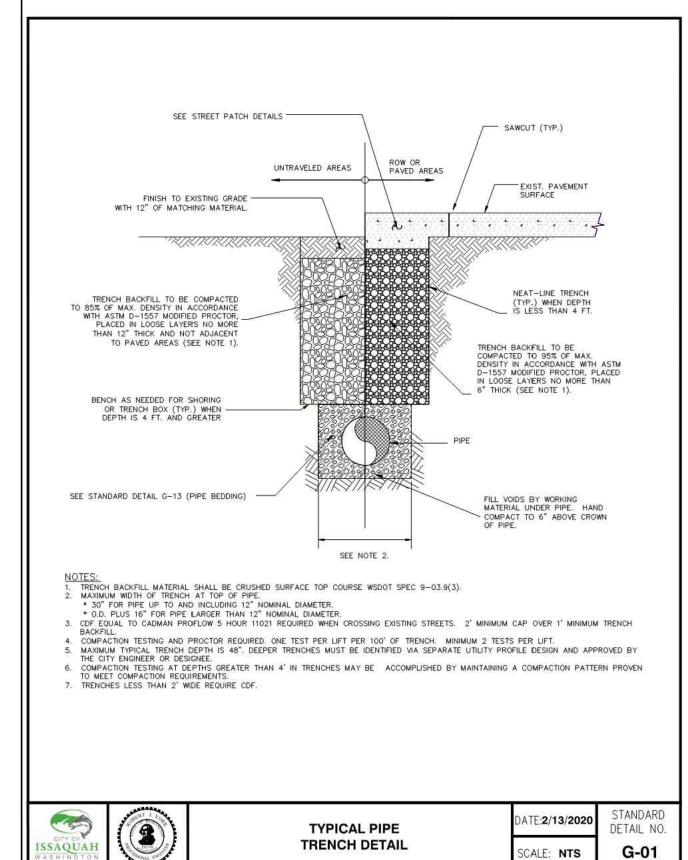

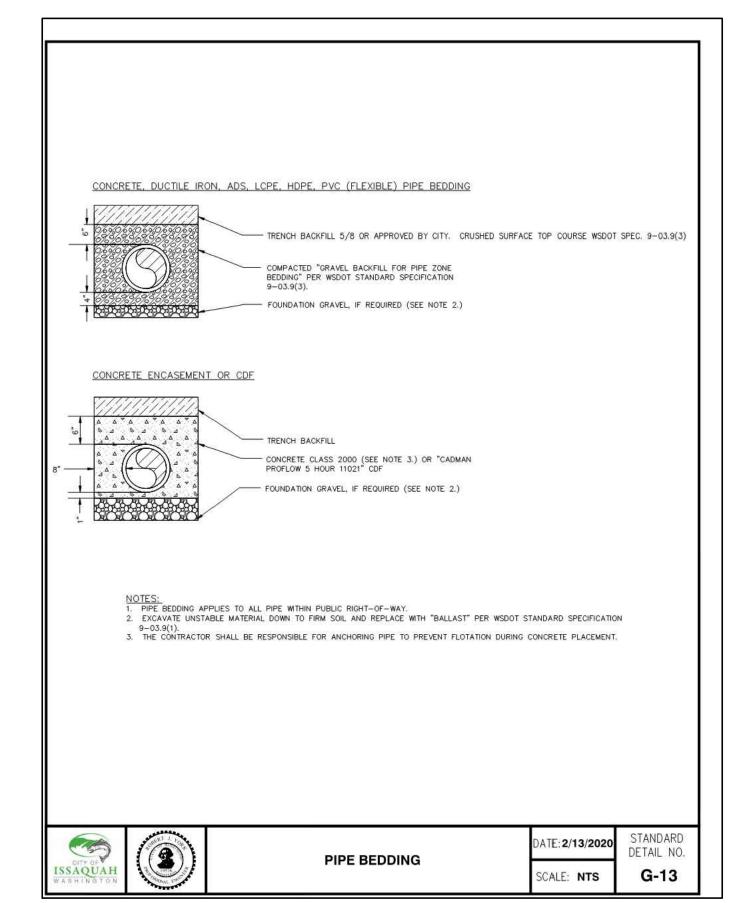

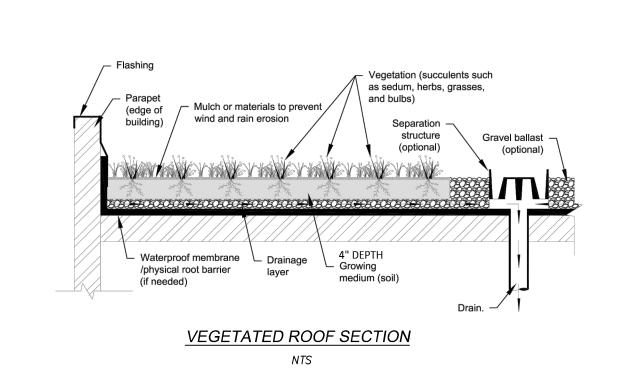

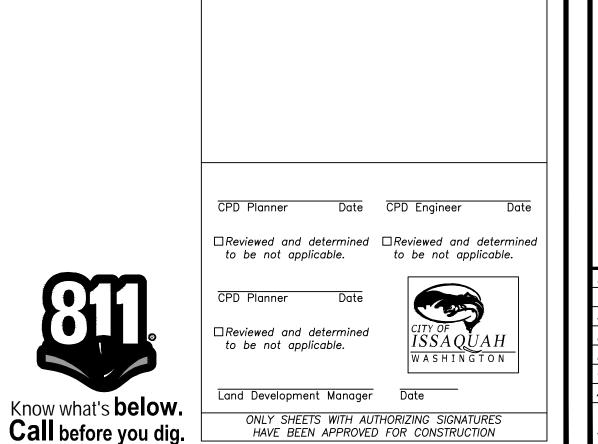

APPROVAL CONDITIONS

09/29/2022 DAYC, DE ЕЕРТНІ Q AND S RIGI **D-27** SCALE: NTS

DETAIL

TION


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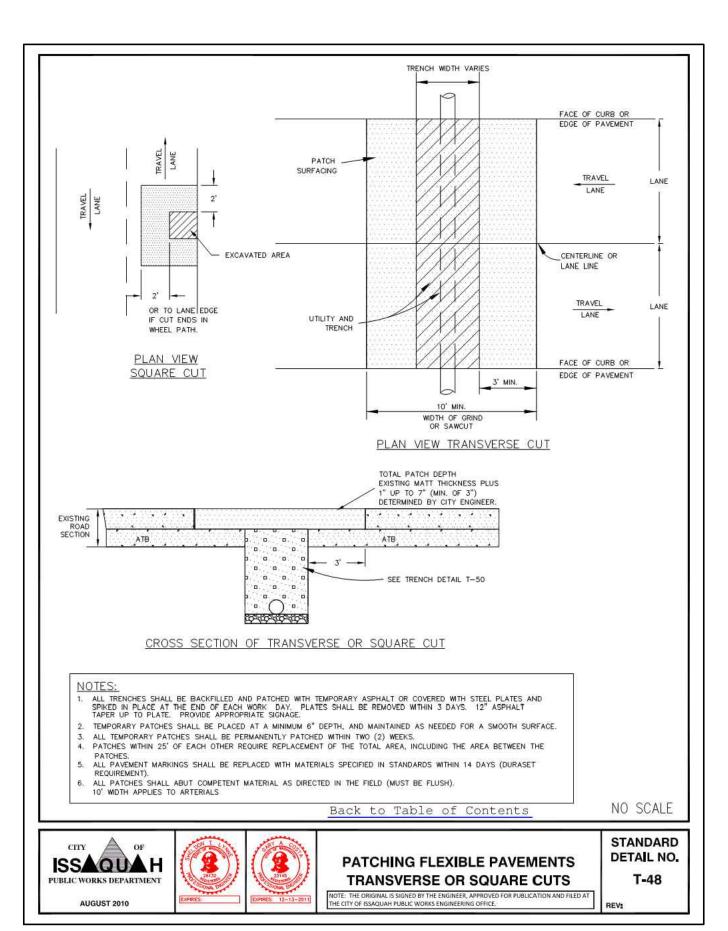
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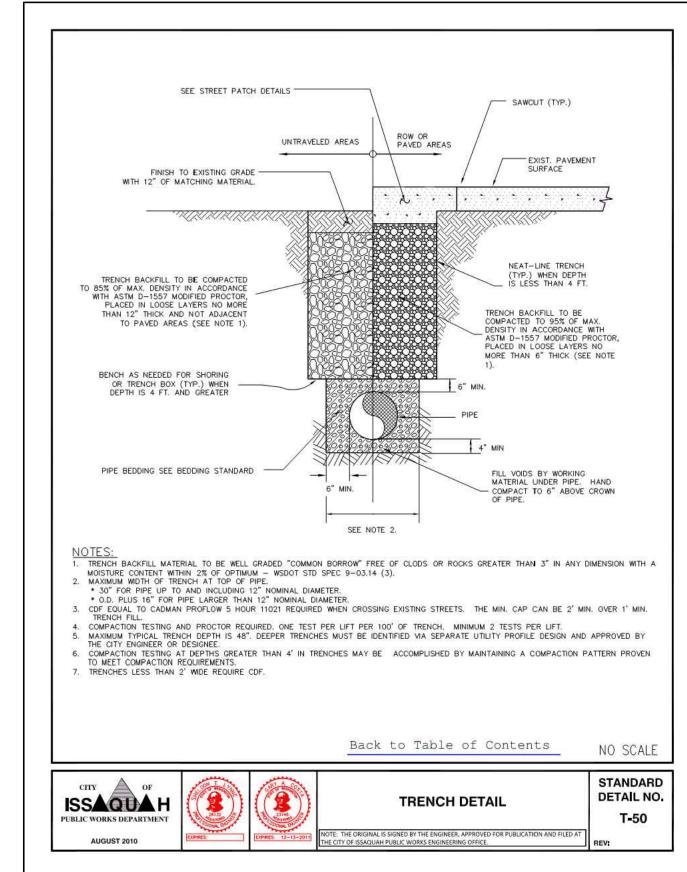
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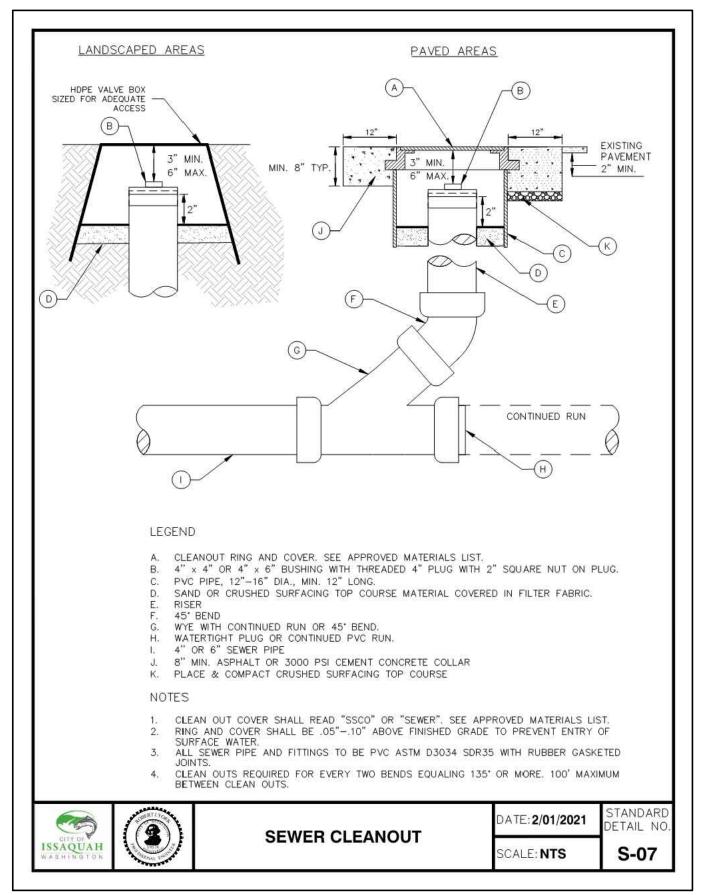
21695 JOB NO. 09/29/202 SCALE NTS DESIGNED BLBPMS DRAWN CHECKED APPROVED SHEET


NE 1/4 OF NW 1/4 OF SECTION 34, T. 24 N., R. 06 E., W.M. CITY OF ISSAQUAH, KING COUNTY, STATE OF WASHINGTON










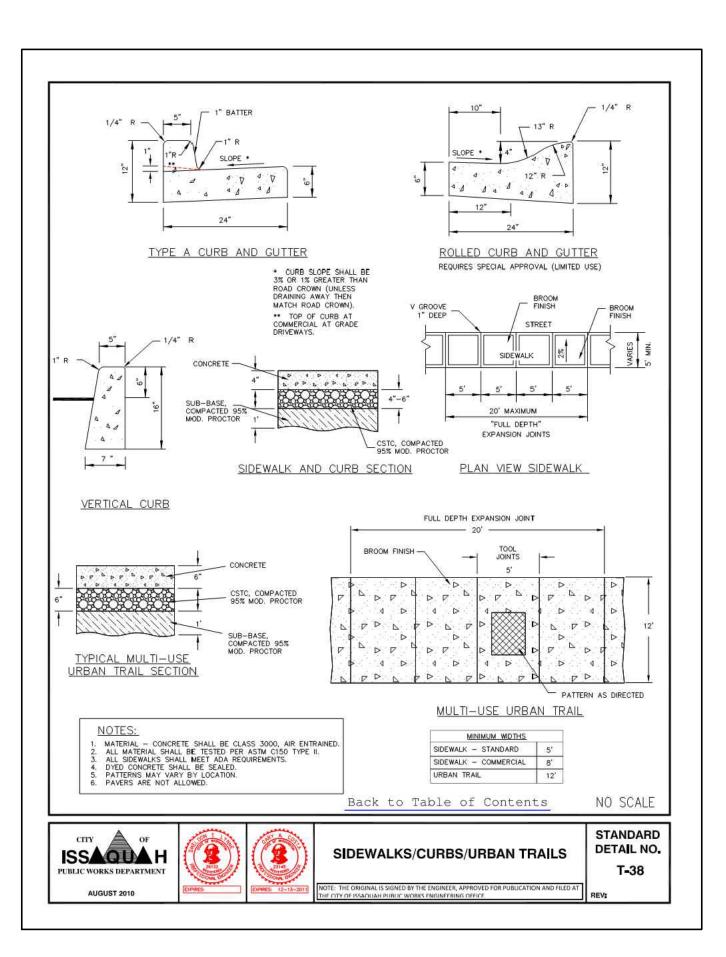


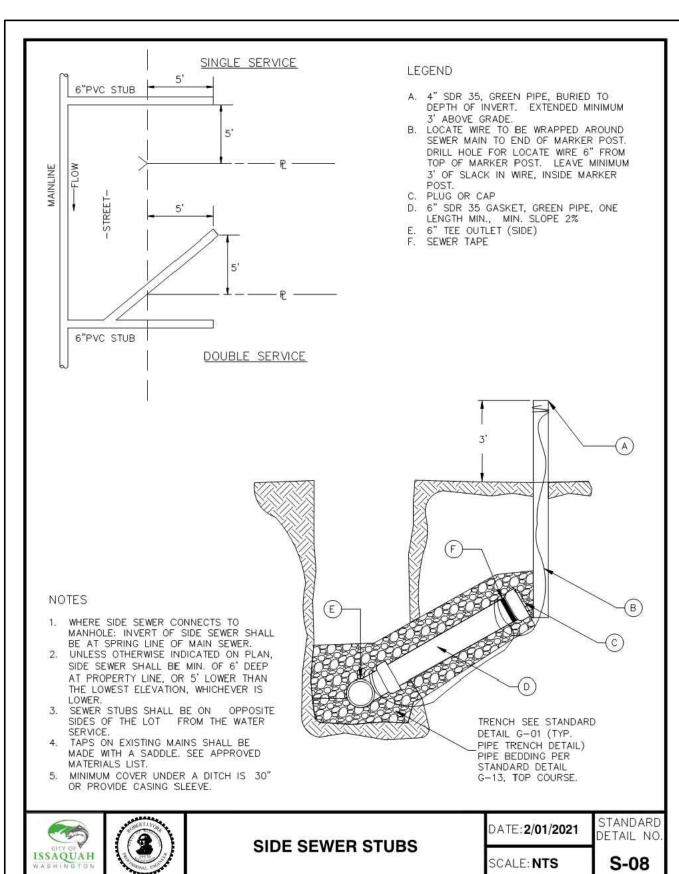

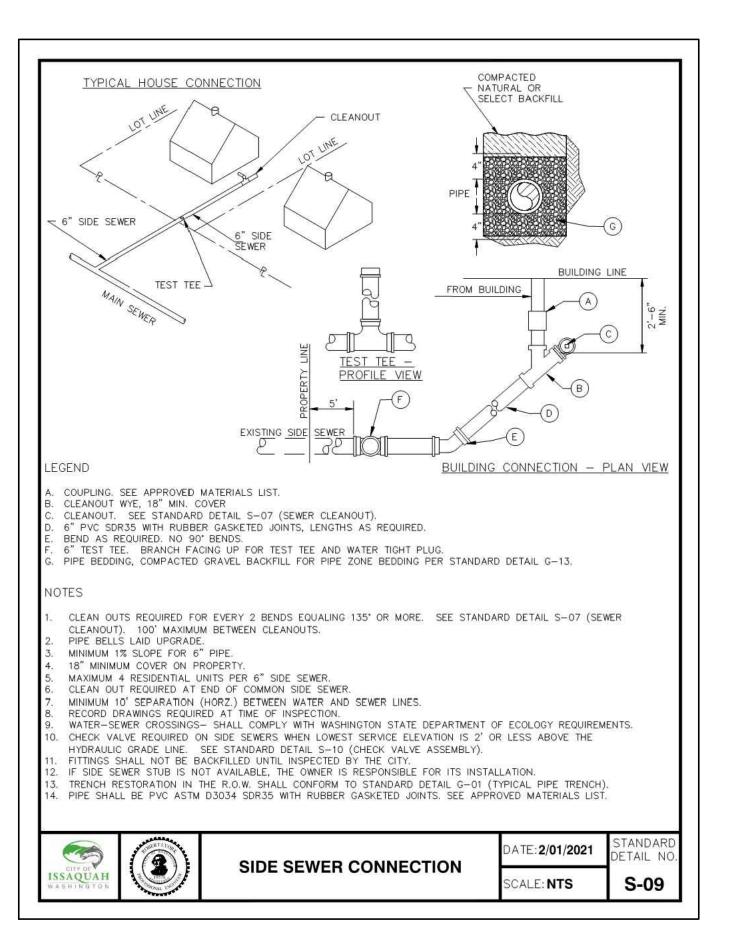

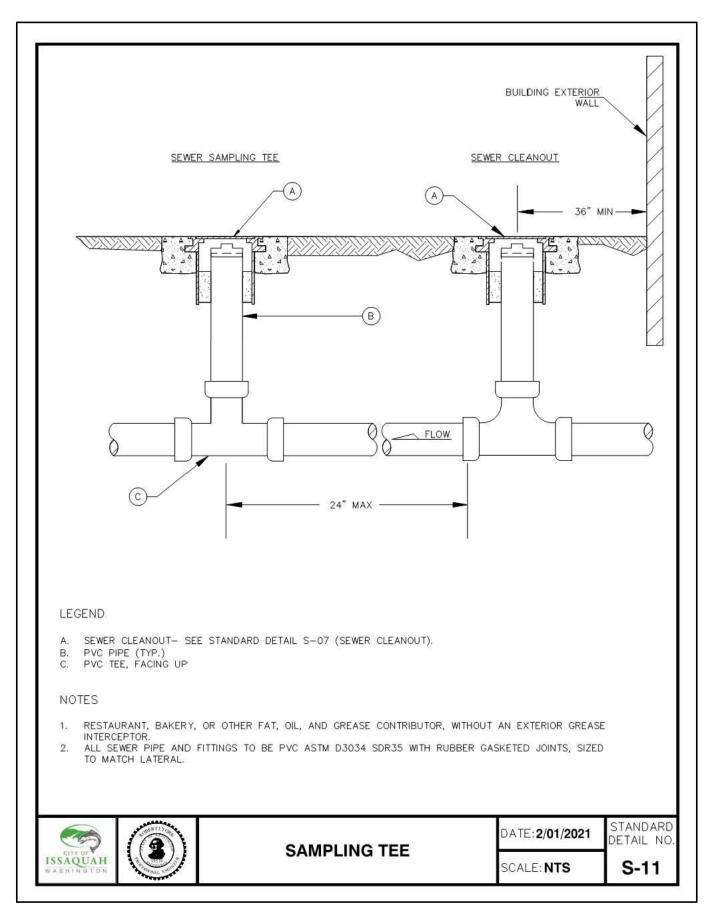

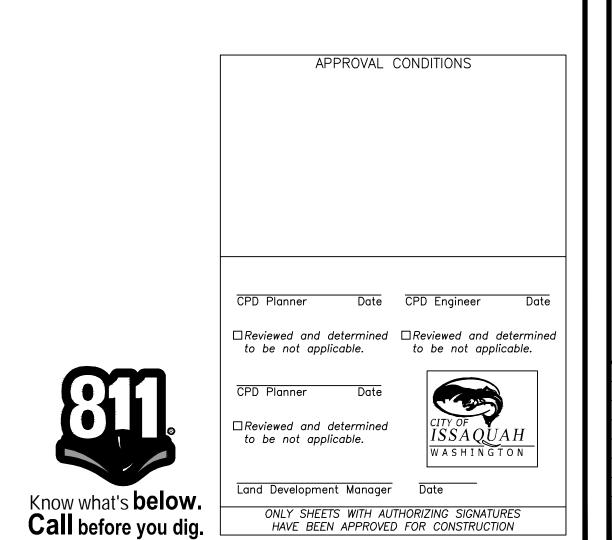

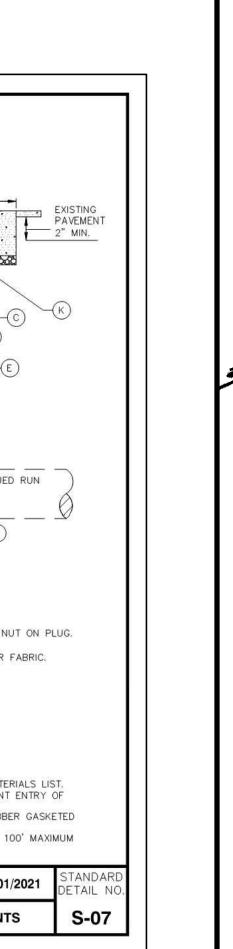

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DAYC,


09/29/2022

TAIL

09/29/202 SCALE NTS PMS

DESIGNED DRAWN CHECKED APPROVED SHEET

NE 1/4 OF NW 1/4 OF SECTION 34, T. 24 N., R. 06 E., W.M. CITY OF ISSAQUAH, KING COUNTY, STATE OF WASHINGTON

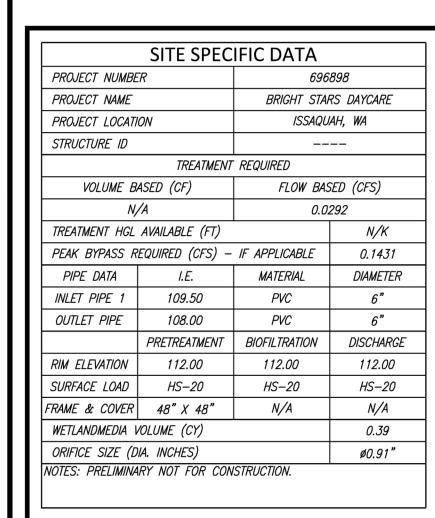

INSTALLATION NOTES

- CONTRACTOR TO PROVIDE ALL LABOR, EQUIPMENT, MATERIALS AND INCIDENTALS REQUIRED TO OFFLOAD AND INSTALL THE SYSTEM AND APPURTENANCES IN ACCORDANCE WITH THIS DRAWING AND THE MANUFACTURERS' SPECIFICATIONS, UNLESS OTHERWISE STATED IN MANUFACTURER'S CONTRACT.
- UNIT MUST BE INSTALLED ON LEVEL BASE. MANUFACTURER RECOMMENDS A MINIMUM 6" LEVEL ROCK BASE UNLESS SPECIFIED BY THE PROJECT ENGINEER. CONTRACTOR IS RESPONSIBLE FOR VERIFYING PROJECT ENGINEER'S RECOMMENDED BASE SPECIFICATIONS. CONTRACTOR TO SUPPLY AND INSTALL ALL EXTERNAL CONNECTING
- PIPES. ALL PIPES MUST BE FLUSH WITH INSIDE SURFACE OF CONCRETE (PIPES CANNOT INTRUDE BEYOND FLUSH). INVERT OF OUTFLOW PIPE MUST BE FLUSH WITH DISCHARGE CHAMBER FLOOR. ALL PIPES SHALL BE SEALED WATERTIGHT PER MANUFACTURER'S STANDARD CONNECTION DETAIL.
- CONTRACTOR RESPONSIBLE FOR INSTALLATION OF ALL PIPES, RISERS, MANHOLES, AND HATCHES. CONTRACTOR TO USE GROUT AND/OR BRICKS TO MATCH COVERS WITH FINISHED SURFACE UNLESS SPECIFIED OTHERWISE.

VEGETATION SUPPLIED AND INSTALLED BY OTHERS. ALL UNITS WITH

VEGETATION MUST HAVE DRIP OR SPRAY IRRIGATION SUPPLIED AND INSTALLED BY OTHERS. CONTRACTOR RESPONSIBLE FOR CONTACTING BIO CLEAN FOR ACTIVATION OF UNIT. MANUFACTURER'S WARRANTY IS VOID WITHOUT

TABLE THIS SHEET

STAINLESS STEEL (SINGLE STRAP) SERVICE SADDLE WITH TAPER (CC)

COMPRESSION FOR COPPER OUTLET. CORP SHALL BE ORIENTED WITH

• 3/4" METER - 7 1/2" x 1" THRD PIPE WTIH METER ADAPTORS.

-HAND COMPACTED

TAP, DOUBLE STRAP FOR 12" AND LARGER PIPES.

CORPORATION STOP; TAPER (CC) INLET x

1" TYPE K SOFT COPPER WITH NO JOINTS

1" = FORD VBH94-15W-4M-44ZA-Q-NL

1" METER - 10 3/4" X 1 1/4" THRD PIPE.

PVC JUMPER: DRILL - 1/4" HOLES

SENSUS 3/4" i-PERL, 7.5" LL, CCF

SENSUS 1" i-PERL, 10.5" LL, CCF

H. METER ADAPTORS FOR A 3/4" SERVICE

DFW1324CNP4-18 BODY
 DFW1324SL-4MA2 LID

• 1" = MUELLER 391B25804R2-01N

ROMAC SSI FOR AC.

D. 1" METER SETTER

METER:

FORD A24

J. 6" OF 5/8" GRAVEL

OPERATING STEM FACING UP. FORD FB1000-4-0-NL FOR 1

MUELLER B-25008N FOR 1"

ROMAC 101NS FOR UP TO 12" DUCTILE & CAST IRON.

ROMAC 202NS FOR 12" OR LARGER DUCTILE & CAST IRON.


A BEDDING UNDER CORP.

PROPER ACTIVATION BY A BIO CLEAN REPRESENTATIVE.

GENERAL NOTES


LEGEND

MANUFACTURER TO PROVIDE ALL MATERIALS UNLESS OTHERWISE NOTED. ALL DIMENSIONS. ELEVATIONS. SPECIFICATIONS AND CAPACITIES ARE SUBJECT TO CHANGE. FOR PROJECT SPECIFIC DRAWINGS DETAILING EXACT DIMENSIONS, WEIGHTS AND ACCESSORIES PLEASE CONTACT BIO CLEAN.

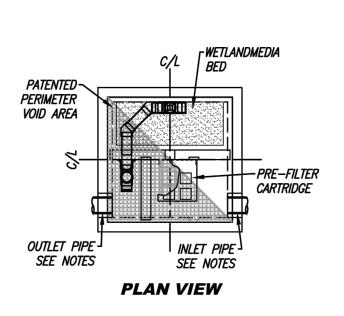

LOW INFLOW PIPE DISCLOSURE:


IT IS RECOMMENDED THAT A SUFFICIENT VARIATION IN ELEVATION BETWEEN THE INLET AND OUTLET BE PROVIDED TO ALLOW FOR ACCUMULATION OF SEDIMENT IN THE PRE-TREATMENT CHAMBER. FAILURE TO DO SO MAY RESULT IN BLOCKAGE AT INFLOW POINT(S) WHICH MAY CAUSE UPSTREAM FLOODING.

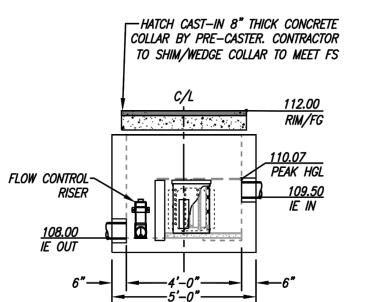

ELEVATION VIEW

INTERNAL BYPASS DISCLOSURE:

THE DESIGN AND CAPACITY OF THE PEAK CONVEYANCE METHOD TO BE REVIEWED AND APPROVED BY THE ENGINEER OF RECORD. HGL(S) AT PEAK FLOW SHALL BE ASSESSED TO ENSURE NO UPSTREAM FLOODING. PEAK HGL AND BYPASS CAPACITY SHOWN ON DRAWING ARE USED FOR GUIDANCE ONLY.

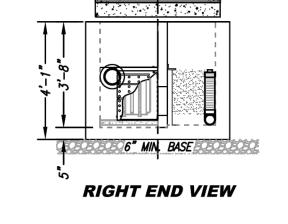

LEFT END VIEW

MWS-L-4-4-3'-7"-V-UG				
TLAND MEDIA LOADING RATE (GPM/SF)	1.0			
RETREATMENT LOADING RATE (GPM/SF)	1.1			
PERATING HEAD (FT)	2.0			
EATMENT FLOW (CFS)	0.031			

STORMWATER BIOFILTRATION SYSTEM

DUCT TAPE ENDS BOX #1

(EITHER DIRECTION)

ARC LENGTH TABLE

PE SIZE | 8" | 12" | 16" | 24

ARC LENGTH | 2" | 3" | 4" | 6"

NOTES:

MEASURED DISTANCE

SERVICE LINE MUST BE INSTALLED PERPENDICULAR TO THE

BE INSTALLED 12" APART AND STAGGERED.

POSITIVE DRAINAGE AWAY FROM BOX.

WATER MAIN. BACKFILL WITH 5/4" MINUS TO 6" OVER PIPE

COMPACT TO 95% MAX. DRY DENSITY PER ASTM D-1557.

4. SERVICE SADDLES ARE REQUIRED ON ALL PIPE EXCEPT CLASS

52 OR THICKER DUCTILE IRON. THE CORP. STOP MAY BE TAPPED DIRECTLY INTO CLASS 52 OR THICKER DUCTILE IRON

PIPE FOR 1" TAPS. ADD 6" \$" ROCK COMPACT TO WSDOT

5. SET BOX AT GRADE AND LEVEL WITH GRADE - PROVIDE

6. DOUBLE OR MULTIPLE SERVICES MUST BE NO MORE THAN 2

FEET APART - 6" IN SIDEWALKS (WHERE APPROVED).

METER LOCATIONS SHALL BE APPROVED BY CITY. AVOID VEHICLE TRAVEL AREAS WHENEVER POSSIBLE.

8. SERVICES SHALL BE INSTALLED BY THE CITY ON CITY OWNED

CITY SHALL INSTALL METER UNLESS OTHERWISE APPROVED.

INDIVIDUALLY TAGGED. SECURE WITH WIRE—TIE TO LOWER LOCKING EAR OF SETTER. TAG MUST BE STAMPED OR

ENGRAVED WITH HOUSE NUMBER. FONT SIZE MINIMUM X"

REDUCTION OF LEAD IN DRINKING WATER ACT, NSF/ANSI

METER ADAPTOR ON 3/4" JUMPER WHEN A 3/4" WATER

14. ALL MATERIAL SHALL BE CERTIFIED "LEAD FREE". REFER TO

STANDARD 61 AND/OR 372, WA DOH PUB. 331-473.

15. CONTRACTOR SHALL INSTALL 5/8" X 3/4" TO 1" WATER

CONTRACTOR SHALL CONNECT PIPING FROM HOUSE TO METER SETTER PRIOR TO RADIO READ METER INSTALLATION.


9. SERVICES SHALL NOT BE TAPPED OFF HYDRANT OR FIRE

10. FILL METER BOX TO TOP WITH UN-COMPACTED CEDAR

13. ALL MULTIPLE METER BOXES THREE OR MORE MUST BE


SERVICE TAPS WILL BE MINIMUM 18" FROM BELL OR SPIGOT.


IF TWO OR MORE SERVICES ARE REQUIRED THEN TAPS WILL

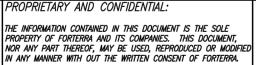






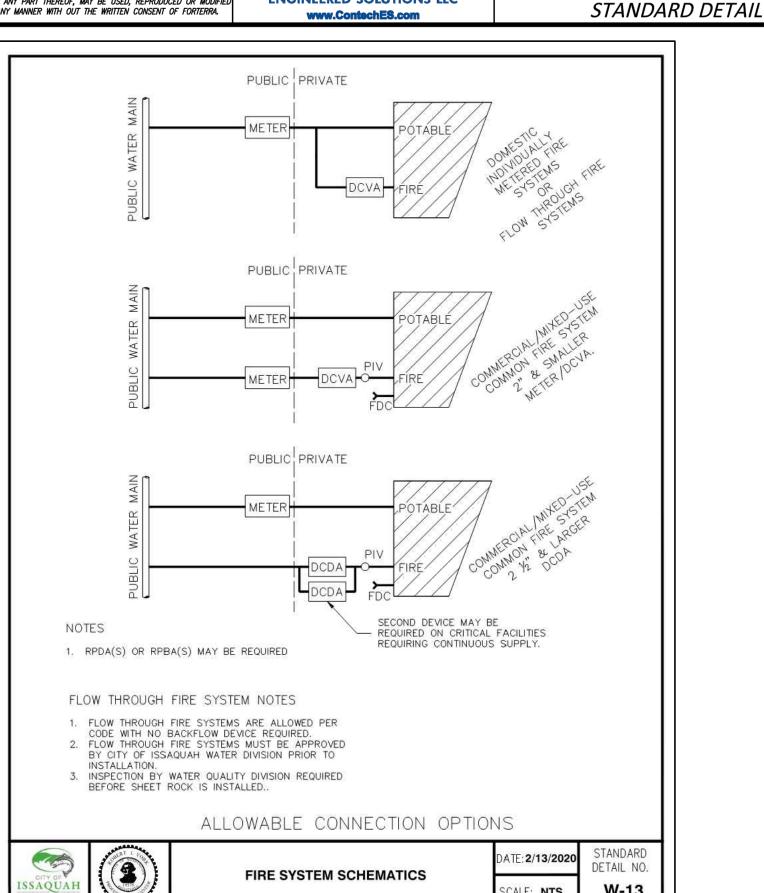

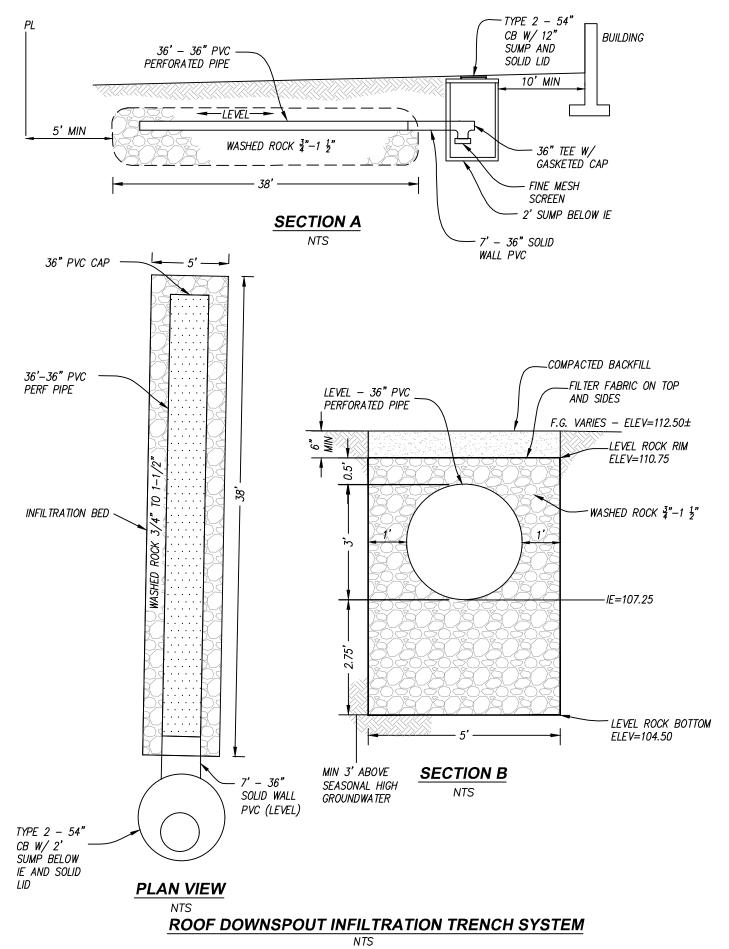

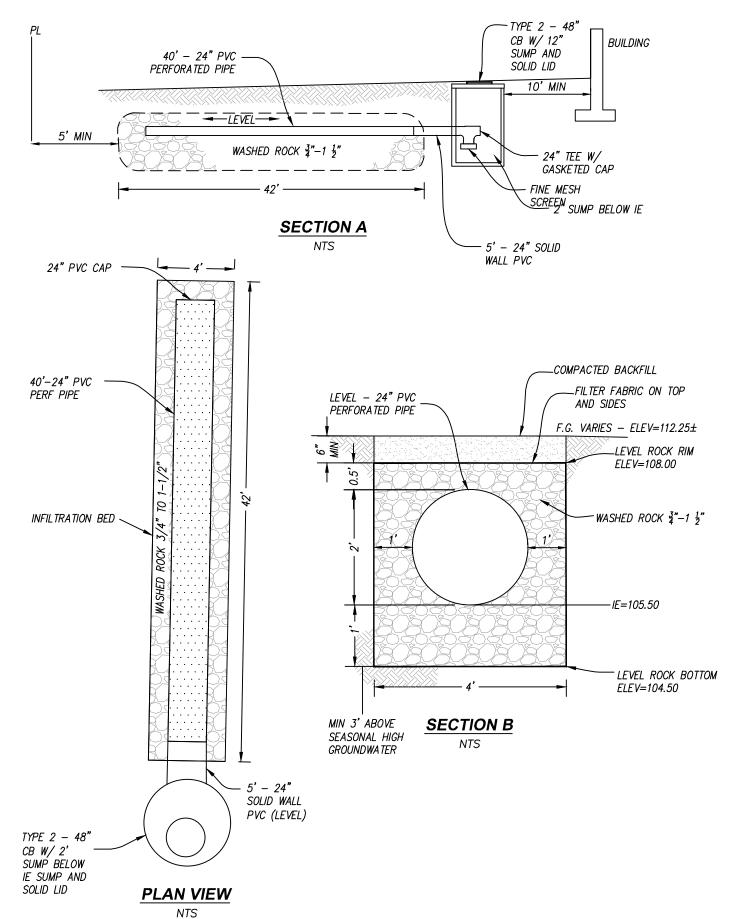

PARKING LOT INFILTRATION TRENCH SYSTEM




APPROVAL CONDITIONS Date CPD Engineer \square Reviewed and determined \square Reviewed and determined to be not applicable. to be not applicable. CPD Planner □ Reviewed and determined to be not applicable.

ONLY SHEETS WITH AUTHORIZING SIGNATURES

HAVE BEEN APPROVED FOR CONSTRUCTION

Land Development Manager

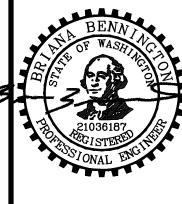

09/29/2022

0 0 RIGI

21695 09/29/202 SCALE NTS DESIGNED BLBPMS DRAWN CHECKED APPROVED

SHEET

3/4" AND 1" METER SERVICE FOR DOMESTIC, IRRIGATION, AND FIRE

W-13 SCALE: NTS


TREES **BOTANICAL NAME COMMON NAME** NATIVE (N) EVERGREEN ACER CIRCINATUM VINE MAPLE 6-8' HT. MIN, MULTI-TRUNK CERCIDIPHYLLUM JAPONICA KATSURA 2.5" CAL. MIN. CHAMAECYPARIS NOOTKATENSIS WEEPING ALASKAN 10' HT. MIN., B&B 'PENDULA' (EVERGREEN) YELLOW CEDAR GARRYA ELLIPTICA (EVERGREEN) COAST SILKTASSEL 6' HT. MIN, B&B STEWARTIA PSEUDOCAMELLIA JAPANESE STEWARTIA 2.5" CAL. MIN.

 1026 SF PERIMETER LANDSCAPE MIX (TYPE 3 VISUAL BUFFER

BOTANICAL NAME COMMON NAME SIZE/SPACING NATIVE (N) ARCTOSTAPHYLOS UVA-URSI KINNIKINNICK 4" POT, 12" O.C. (N) CORNUS SERICEA 'MIDWINTER FIRE' RED TWIG DOGWOOD 3 GAL, 36" O.C. (N) FRAGARIA CHILOENSIS **BEACH STRAWBERRY** 4" POT, 12" O.C. (N) MAHONIA X MEDIA 'CHARITY' CHARITY MAHONIA 5 GAL, 60" O.C. (N) POLYSTICHUM MUNITUM WESTERN SWORD FERN 2 GAL, 24" O.C. (N) RIBES SANGIUNEUM RED FLOWERING CURRANT 5 GAL, 48" O.C. SYMPHORICARPOS ALBUS SNOWBERRY 3 GAL, 36" O.C. (N) VACCINIUM OVATUM EVERGREEN HUCKLEBERRY 3 GAL, 36" O.C. (N)

STREET FRONTAGE PLANTING MIX

SIZE/SPACING NATIVE (N) **BOTANICAL NAME** COMMON NAME ARCTOSTAPHYLLOS UVA URSI KINNIKINNICK 1 GAL, 18" O.C. (N) 4" POT, 18" O.C. (N) ASARUM CANADENSE WILD GINGER WESTERN RED COLUMBINE AQUILEGIA FORMOSA 1 GAL, 24" O.C. (N) CAREX OSHIMENSIS **EVERGOLD SEDGE** 1 GAL, 24" O.C. CHOISYA X DEWITTEANA 'AZTEC PEARL' MEXICAN ORANGE 'AZTEC PEARL' 3 GAL, 36" O.C. 1 GAL, 18" O.C. DAPHNE ODORA WINTER DAPHNE DESCHAMPSIA CESPITOSA TUFTED HAIR GRASS 1 GAL, 18" O.C. (N) **BEACH STRAWBERRY** FRAGARIA CHILOENSIS 4" POTS, 24" O.C. (N) GAULTHERIA SHALLON 1 GAL, 24" O.C. (N) SALAL NEPETA X FAASSENII 'WALKER'S LOW' 'WALKER'S LOW CATMINT 1 GAL, 18" O.C. SWITCH GRASS 'SHENENDOAH' 1 GAL, 18" O.C. PANICUM VIRGATUM SHENANDOAH PEROVSKIA ATRIPLICIFOLIA **RUSSIAN SAGE** 2 GAL, 24" O.C. PENNISETUM ALOPECUROIDES 'HAMELN' FOUNTAIN GRASS 2 GAL, 24" O.C.. POLYSTICHUM MUNITUM WESTERN SWORD FERN 2 GAL, 24" O.C. (N) RAPHIOLEPIS INDICA 'DWARF PINK' DWARF INDIAN HAWTHORN 3 GAL, 36" O.C. RUDBECKIA FULGIDA **BLACK-EYED SUSAN** 1 GAL, 18" O.C. PINK SNOWBERRY 3 GAL, 36" O.C. (N) SYMPHORICARPOS 'SCARLET PEARL' EVERGREEN HUCKLEBERRY 5 GAL, 48" O.C. (N) VACCINIUM OVATUM

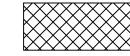

PARKING LOT PLANTING MIX SIZE/SPACING **BOTANICAL NAME** COMMON NAME TUFTED HAIRGRASS DESCHAMPSIA CESPITOSA 1 GAL, 18" O.C. (N) 4" POT, 24" O.C. (N) FRAGARIA CHILOENSIS BEACH STRAWBERRY GERANIUM SPP. HARDY GERANIUM 1 GAL, 24" O.C. LONICERA PILEATA BOX LEAF HONEYSUCKLE 5 GAL., 36" O.C. MAHONIA REPENS CREEPING OREGON GRAPE 2 GAL, 24" O.C. (N) 2 GAL, 24" O.C. (N) POLYSTICHUM MUNITUM WESTERN SWORD FERN

SNOWBERRY

BLACK-EYED SUSAN

3 GAL, 36" O.C. (N)

1 GAL, 18" O.C


VINES FOR TRELLIS AND VERTICAL WALLS:

RUDBECKIA HIRTA

SYMPHORICARPOS ALBUS

COMMON NAME **BOTANICAL NAME** SIZE/SPACING

> AKEBIA SP. SAUSAGE VINE PASSIFLORA CAERULEA PASSION FLOWER VINE HYDRANGEA ANOMALA PETIOLARIS CLIMBING HYDRANGEA

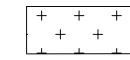


1938 SF SOD TURF

000000000

1,596 SF GREEN ROOF SEDUM MATS - COLUMBIA GREEN; TUFF STUFF MIX.



~ASPHALT~

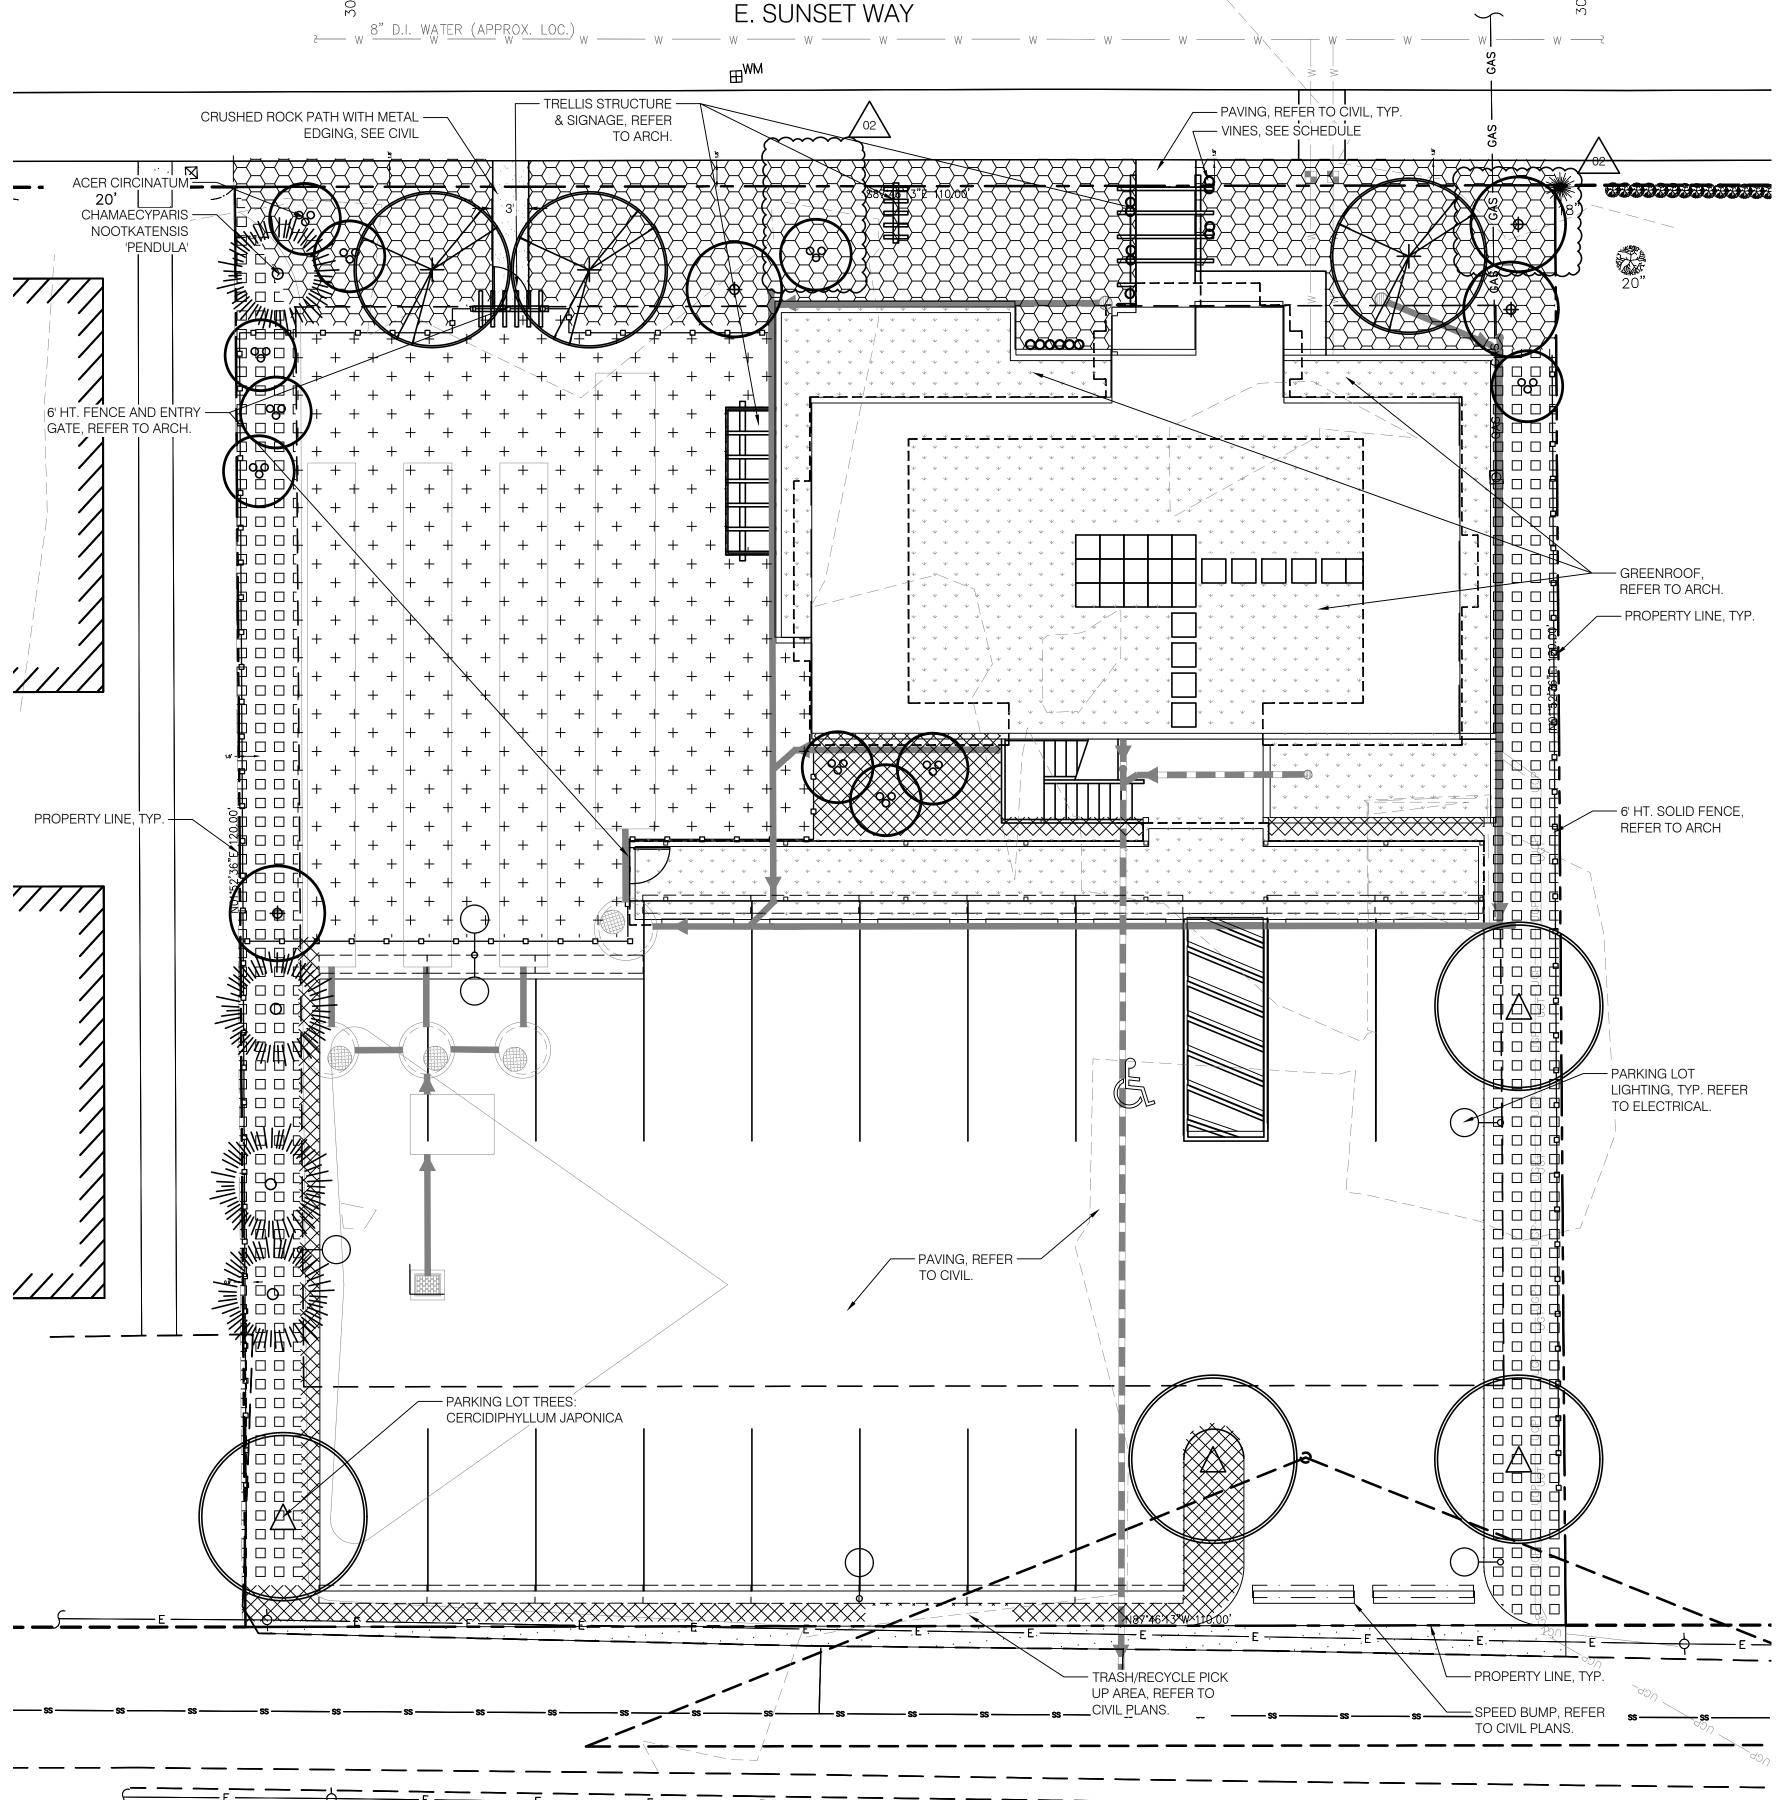

SITE PLAN



NORTH

*

A AMIL AR hi De eepthi Ŏ BRIGH Tharaka

SET WAY 98027

355 EAST SUNSE ISSAQUAH, WA 9

ARE

C

SCHEMATIC DESIGN

REVISIONS: REV-01 09.29.2022 REV-02 XX.XX.2022

12.21.2021

DRAWN/CHECKED: CONCEPT PLAN

SHEET NUMBER:

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